


ARCHITECTURAL ABBREVIATIONS

ABOVE FINISHED FLOOR	A.F.F.	KNOCK-OUT PANEL	K.O.P.
ACCESS DOOR	A.D.	LAMINATE LAMINATED	L.A.M.
ACCESS PANEL	A.P.	LEFT HAND	L.H.
ACOUSTIC ACOUSTICAL	ACOUS.	LEFT HAND REVERSE	L.H.R.
ACOUSTIC PANEL CEILING	A.P.C.	LIGHT	L.T.
ADDITION	ADD.	LIGHTING PANEL	L.T.P.
ADJUSTABLE	ADJ.	LIGHTWEIGHT	L.T.W.
ALTERNATE	ALT.	LIVE LOAD	L.L.
ALUMINUM	ALUM.	LONG LEG HORIZONTAL	L.L.H.
ANCHOR ANCHORAGE	ANCH.	LONG LEG VERTICAL	L.L.V.
ANCHOR BOLTS	A.B.	LOUVER OPENING	L.O.
AND	&	LOW POINT	L.O.P.
ANGLE	ANG.	MACHINE	MACH.
AUXILIARY	AUX.	MANHOLE	M.H.
APPROVED	APPR.	MARBLE THRESHOLD	M.T.
APPROXIMATE	APPROX.	MASKER BOARD	M.B.
ARCHITECT, ARCHITECTURAL	ARCH.	MASONRY	MAS.
ASPHALT	ASPH.	MASONRY OPENING	M.O.
ASSEMBLY	ASSEMBLY	MATERIAL	MATL.
ASSISTANT	ASSIST.	MAXIMUM	MAX.
AT	@	MECHANICAL	MECH.
AUTOMATIC	AUTO	MEDIUM	MED.
AUXILIARY	AUX.	METAL or METALLIC	M.T.L.
BARRIER FREE	B.F.	METAL EDGE STRIP	M.E.S.
BASE PLATE	B. PL.	MEZZANINE	MEZ.
BASEMENT	BSMT	MINIMUM	MIN.
BEAM	BM	MISCELLANEOUS	MISC.
BEARING	BRG.	MOUNTED	MTD.
BENCH MARK	B.M.	MULLION	MULL.
BETWEEN	BET.	NATURAL	NAT.
BITUMINOUS	BITUM.	NOMINAL	NOM.
BLOCK	BLK.	NORTH	N.
BLOCKING	BLKG	NOT IN CONTRACT	N.I.C.
BOARD	BD	NOT TO SCALE	N.T.S.
BOTTOM	BTM	NUMBER	NO. or #
BUILDING	BLDG	OFFICE	OFF.
BUILT-UP ROOFING	B.U.R.	ON CENTER	O.C.
CABINET	CAB.	OPENING	OPNG
CABINET UNIT HEATER	C.U.H.	OPPOSITE	OPP.
CATCH BASIN	C.B.	OUTSIDE HAND	O.H.
CEILING	CLG	OUTSIDE DIAMETER	O.D.
CENTER LINE	C.L.	OVERHEAD	O.H.
CENTER TO CENTER	C/C	OVERFLOW ROOF CONDUCTOR	O.R.C.
CERAMIC	CER.	PAINTED	P.T.D.
CERAMIC TILE	C.T.	PAIR	PR
CHALKBOARD	CHALK BD.	PANEL JOINT	P.J.
CHANNEL	C	PAPER TOWEL DISPENSER	P.T.D.
CLOSET	CL	PARTITION	PARTN
COLD WATER	CW	PERFORATED	PERF.
COLUMN	COL	PERIMETER	PERIM.
COMPACTED	COMP.	PLASTER	PLAS.
CONCRETE	CONC.	PLASTIC LAMINATE	P.L.A.M.
CONCRETE MASONRY UNIT	C.M.U.	PLATE	PLT.
CONFERENCE	CONF.	PLYWOOD	PLYWD
CONNECT, CONNECTION	CONN.	POINT	PTS
CONSTRUCTION	CONSTR.	POINTS	PTS.
CONTROL or CONSTRUCTION JOINT	C.J.	POLISH, POLISHED	POL.
CONTINUE, CONTINUOUS	CONTIN.	POLYVINYL CHLORIDE	P.V.C.
CONTR.	CONTR.	POUND	POUN.
CORRIDOR, CORRUGATED	CORR.	POUNDS PER SQUARE FOOT	P.S.F.
DAMP PROOFING	D.P.	POUNDS PER SQUARE INCH	P.S.I.
DEAD LOAD	D.L.	POWER	PWR.
DEMOLITION	DEMO	PRECAST	P.C.
DEPARTMENT	DEPT.	PREFABRICATED	PREFAB.
DETAIL	DET.	PRESSURE TREATED	P.T.
DIAMETER	DIA.	PROJECT, PROJECTION	PROJ.
DIFFUSER	DIFF.	PROPERTY	PROP.
DIMENSION	DIM.	QUARRY TILE	Q.T.
DIRECTORY	DIR.	RADIUS	RAD.
DITTO	DO	REFRIGERATION or REFRIGERATOR	REF.
DOOR	DR	REINFORCE REINFORCING or REINFORCEMENT	REINF.
DOOR OPENING	D.O.	REQUIRED	REQD.
DOUBLE	DBL	RESILIENT BASE	R.B.
DOWN	DN	REVISED, REVISION	REV.
DOWELS	DWLS	RIGHT HAND	R.H.
DRAWING	DWG	RIGHT HAND REVERSE	R.H.R.
DRINKING FOUNTAIN	D.F.	RIGHT OF WAY	R.O.W.
EACH	EA	RISER	R.
EACH FACE	E.F.	ROOF CONDUCTOR	R.C.
EACH WAY	E.W.	ROOM	RM.
ELECTRIC ELECTRICAL	ELEC.	ROUGH OPENING	R.O.
ELECTRICAL PANEL	E.P.	ROUND	RND.
ELECTRIC WATER COOLER	E.W.C.	RUBBER TILE	R.T.
ELEVATION (HEIGHT LEVEL)	EL.	SANITARY	SAN.
ELEVATOR	ELEV.	SANITARY NAPKIN DISPOSAL	S.N.D.
ELIMINATE	ELIM.	SCHEDULE	SCHED.
EMERGENCY	EMERG.	SECTION	SECT.
ENAMEL	ENAM.	SERVICE SINK	S.S.
ENCLOSURE	ENCL.	SHIT	SH.
ENVIRONMENT	ENVR	SIMILAR	SIM.
EQUAL	EQ.	SOAP DISPENSER	SD
EQUIPMENT	EQP.	SOUTH	S.
EXCAVATED	EXC.	SPEAKER	SPKR
EXISTING	EXG.	SPECIFICATIONS	SPC.
EXPANSION	EXP.	SQUARE FEET (FOOT)	S.F.
EXPANSION BOLT	EXP. B.	STAINLESS STEEL	S.S.
EXPANSION JOINT	EXP. J.	STANDARD	STD.
EXTERIOR	EXT.	STEEL	STL.
FABRIC	FAB.	STORAGE	STOR.
FEET FOOT	FT.	STREET	ST.
FINISH FINISHED	FIN.	STRUCTURAL	STRUCT.
FINISH FLOOR ELEVATION	F.F.E.	SUSPEND, SUSPENSION	SUSP.
FIRE ALARM	F.A.	TACKBOARD	T.B.
FIRE EXTINGUISHER ON BRACKET	F.E.B.	TELEPHONE	TEL.
FIRE EXTINGUISHER CABINET	F.E.C.	TEMPERATURE	TEMP.
FIRE HYDRANT	F.H.	TEMPERED GLASS	T.G.
FIRE HOSE CABINET	F.H.C.	THICK, THICKNESS	THK.
FIRE VALVE CABINET	F.V.C.	THRESHOLD	THRES.
FIREPROOFING	F.P.	TOILET	TLT.
FIXTURE	FIXT.	TOILET PAPER DISPENSER	T.P.D.
FLAT PANEL DISPLAY	FPD	TONGUE AND GROOVE	T & G
FLOOR	FLR.	TOP AND BOTTOM	T & B
FLOOR DRAIN	F.D.	TOP OF	T.O.
FOOTING	FTG	TOP OF BLOCKING	T.O.B.
FOUNDATION	FNDR.	TOP OF FOOTING	T.O.F.
GAUGE	GA.	TOP OF MASONRY	T.O.M.
GALVANIZED	GALV.	TOP OF STEEL	T.O.S.
GALVANIZED IRON	G.I.	TREAD	T.
GENERAL	GEN.	TYPICAL	TYP.
GENERAL CONTRACTOR	G.C.	UNDERWRITER'S LABORATORIES, INC. UNLESS NOTED OTHERWISE	U.L.I.
GLASS	GL.	VENT. THRU ROOF	V.T.R.
GRADE	GR.	VERIFY IN FIELD	V.I.F.
GRASS	GRS.	VERTICAL VERTICALLY	V.V.
HARDWARE	HW	VESTIBULE	VEST.
HANDICAPPED	H.C.	VINYL COMPOSITION TILE	V.C.T.
HEATING, VENTILATION, AIR CONDITIONING	H.V.A.C.	VINYL TILE	V.T.
HIGH POINT	H.P.	VINYL WALL COVERING	V.W.C.
HIGH PRESSURE LAMINATE	H.P.L.	VOLT	V.
HOLLOW METAL	H.M.	WATER RESISTANT	W.R.
HORIZONTAL, HORIZONTALLY	HORIZ.	WATERPROOFING	WP
HOSE BIBB	H.B.	WEIGHT	WGT.
HOT WATER	H.W.	WELDED WIRE FABRIC	W.W.F.
HOT WATER HEATER	H.W.H.	WINDOW	WDO
HYDRANT	HYD.	WELDED WIRE MESH	W.W.M.
INSULATED FIBERGLASS REINF. PANEL	I.F.R.P.	WIRE MESH	W.M.
INCH or INCHES	IN. or "	WITH	W/
INFORMATION	INFO.	WITHOUT	W/O
INSIDE DIAMETER	I.D.	WOOD	WD.
INSTALL, INSTALLATION	INSTAL.	YARD	YD.
INSULATE, INSULATION	INSUL.		
INTERIOR	INT.		
INVERT	INV.		
INVERT ELEVATION	I.E.		
JOINT	JT.		
KICK PLATE	K.P.		

SYMBOL LEGEND

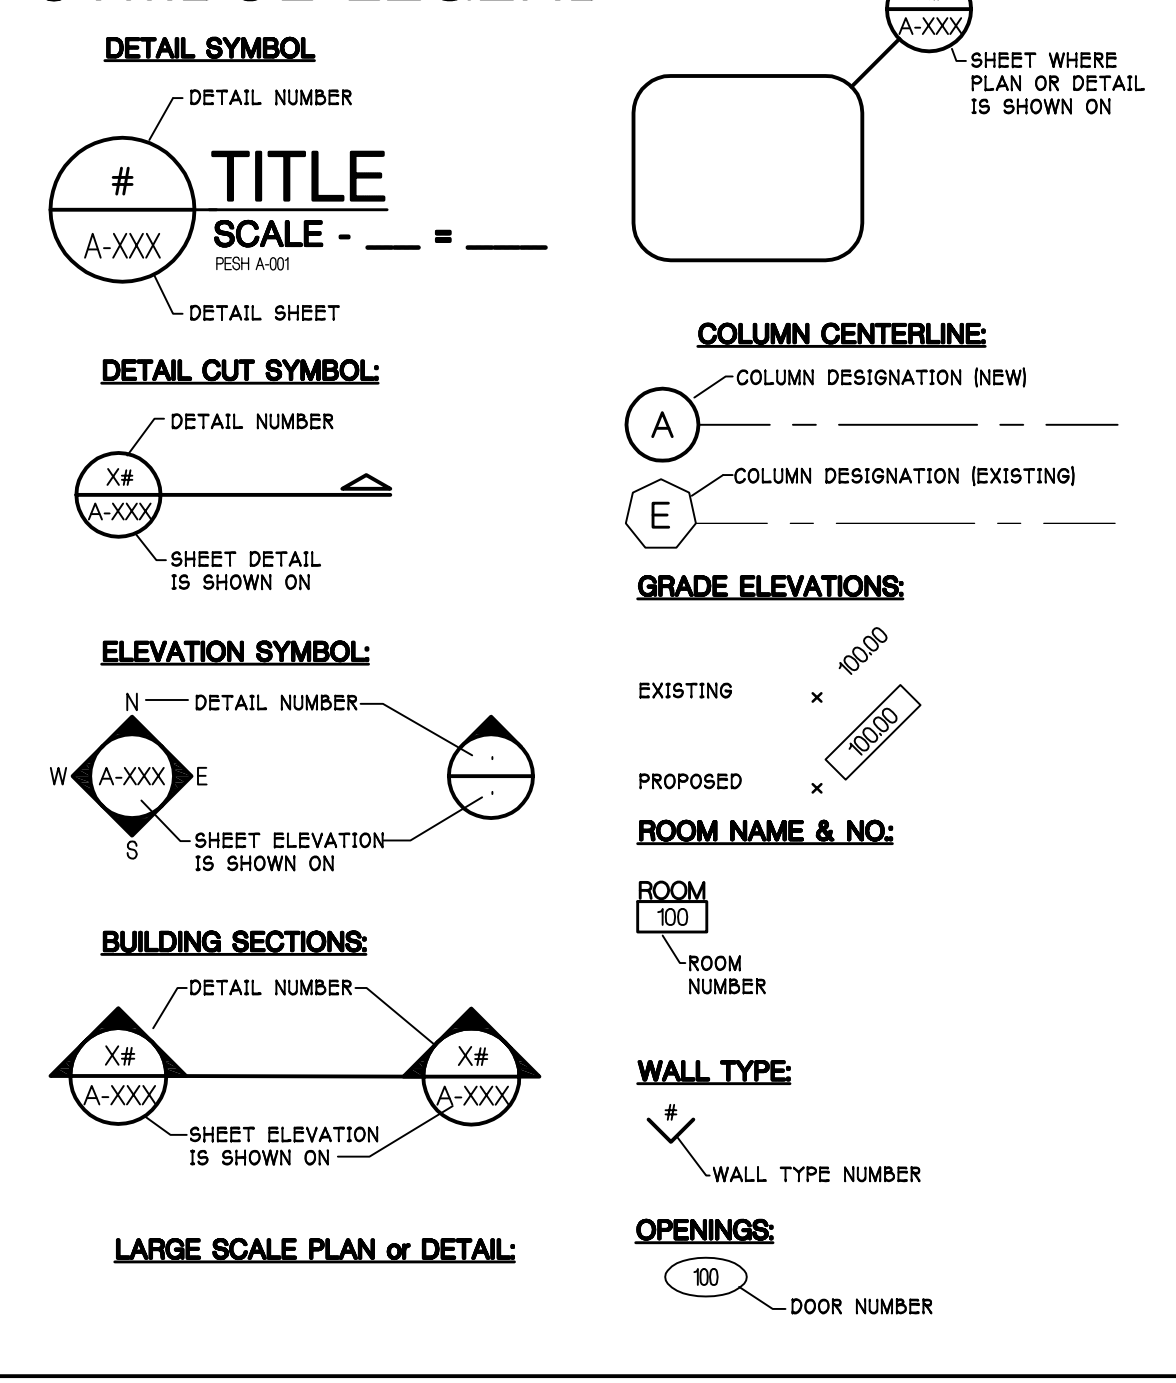

GENERAL NOTES

1. REPLACE ALL CALL STATION ELECTRONICS AT EACH FLOOR.
2. REPLACE ALL CAR OPERATION PANELS IN ALL ELEVATOR CARS.
3. REPLACE ALL HALL LANTERNS AT EACH FLOOR STOP FOR EACH ELEVATOR
4. REPLACE ALL TACTILE SIGNAGE AT JAMBS OF ELEVATOR ENTRANCES AND REPLACE W/ NEW
5. ALL EXISTING PIT LADDERS ARE TO REMAIN. LADDERS TO BE PREPED AND PAINTED.
6. EXISTING PIT FLOOR TO BE CLEANED OF ALL OIL, OIL ABSORBING MATERIAL AND ANY OTHER FOREIGN MATERIAL NOT PERMITTED TO BE IN ELEVATOR SHAFT.
7. COVER AND PROTECT ALL ADJACENT WORK AREAS PRIOR TO COMMENCEMENT OF WORK.
8. VERIFY ALL DIMENSIONS OR IMPLIED MEASUREMENTS PRIOR TO COMMENCEMENT OF WORK.
9. VERIFY NEW SUMP PIT LOCATIONS WITH FIELD CONDITIONS. ROUTE PIPING TO NOT INTERFERE WITH ELEVATOR EQUIPMENT.
10. ALL PENETRATIONS OF ELEVATOR PIT WALLS TO BE FIRE RATED TO MAINTAIN FIRE RATING OF SHAFT.
11. ALL HAND RAILS TO BE REPLACED WITH SIMILAR TO EXISTING.
12. CONTRACTORS TO MAINTAIN SAFE AND CLEAN WORK AREAS FOLLOWING ALL APPLICABLE CODES
13. VERIFY EXISTING CEILING TILE AND GRID REMOVAL AND REINSTALLATION WITH ROUTING OF SUMP PUMP PIPING. SEE PLUMBING

FINISH MATERIALS

1. FLOOR FINISH MATERIALS FOR ELEVATOR 1 TO BE DIAMOND PLATE
2. FLOOR FINISH FOR ELEVATORS 4 AND 6 TO BE: CARPET TILE TARKETT, RUNAWAY 11-FALLING LEAVES, 24X24-ERS TIL, 0316424X24EX18214
3. FLOOR FINISH FOR ELEVATORS 2, 3, 5 AND 6 TO BE: SHAW CARPET, STYLE: PORTAL 5T035; COLOR: NAVY 34485.
4. NEW HOLLOW METAL DOOR FRAMES TO ABE PAINTED TO MATCH ADJACENT WALL COLOR.

KEY NOTES

- A SAW CUT AND INSTALL NEW 2'-0"x2'-0"x2'-0" FIBERGLASS BASIN ENCASED IN CONCRETE. PATCH FLOOR AS NEEDED FOR NEW SUMP PIT SANITARY.
- B NEW CARPET TILES - TILES TO MATCH CARPET TILES AT ELEVATOR FIRST FLOOR STOP.
- C REMOVE EXISTING WALL PANELS AND REPLACE WITH NEW. - STYLE, COLOR AND MATERIAL TO MATCH EXISTING UNLESS NOTED OTHERWISE.
- D REMOVE EXISTING ELEVATOR EQUIP. AND PIPE
- E INSTALL NEW DIAMOND FLOOR PLATE PER MANUFACTURER'S INSTRUCTIONS
- F PREP AND PAINT BI-PARTING METAL DOOR
- G PREP AND PAINT EXISTING METAL DOOR
- H REMOVE EXISTING AND REPLACE LIGHTS, PANELS AND FANS

CODE DATA


MICHIGAN REHABILITATION CODE 2015
 LEVEL 2 ALTERATIONS

OCCUPANCY
 LOW HAZARD STORAGE S-1
 NO OCCUPANCY CHANGE

BUILDING DATA
 CONSTRUCTION TYPE II B FULLY
 SPRINKLED

BUILDING HEIGHT
 XX

NUMBER OF STORIES - 5

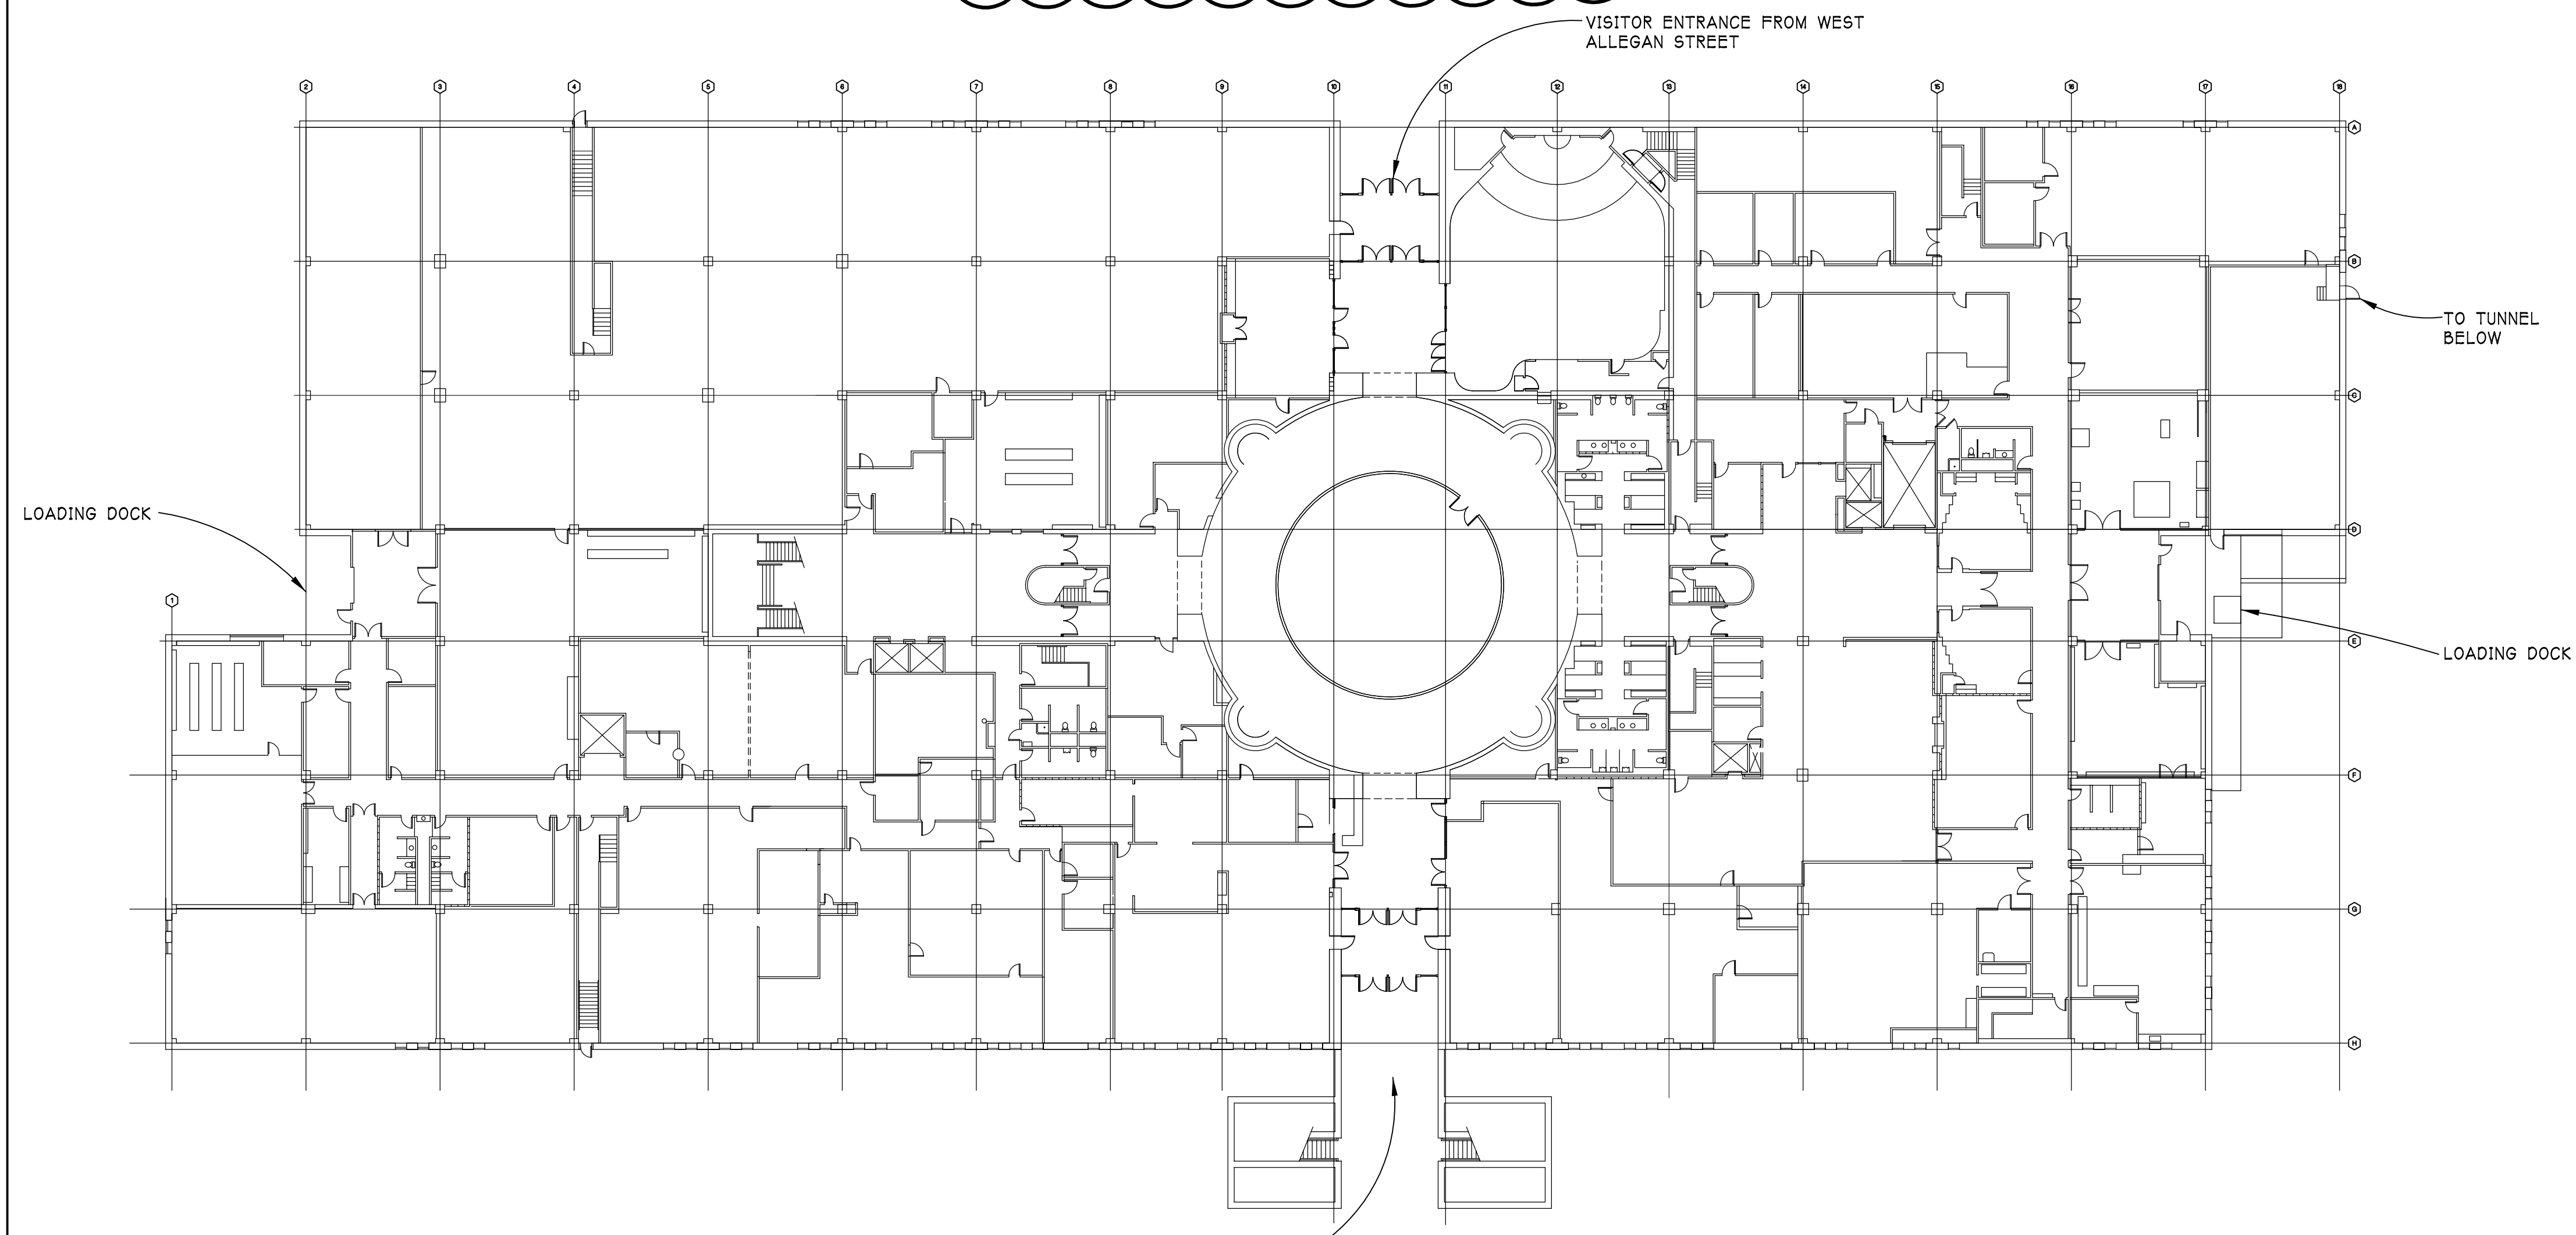

NORTH
CODE COMPLIANCE PLAN
 SCALE - NTS
 PESH A-001

1	ADDENDUM 1	10/01/2021
	ISSUED FOR BIDDING	09/16/2021
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CODE COMPLIANCE SHEET



SHEET TITLE

21-302

PROJECT NUMBER

A-001

SHEET NUMBER

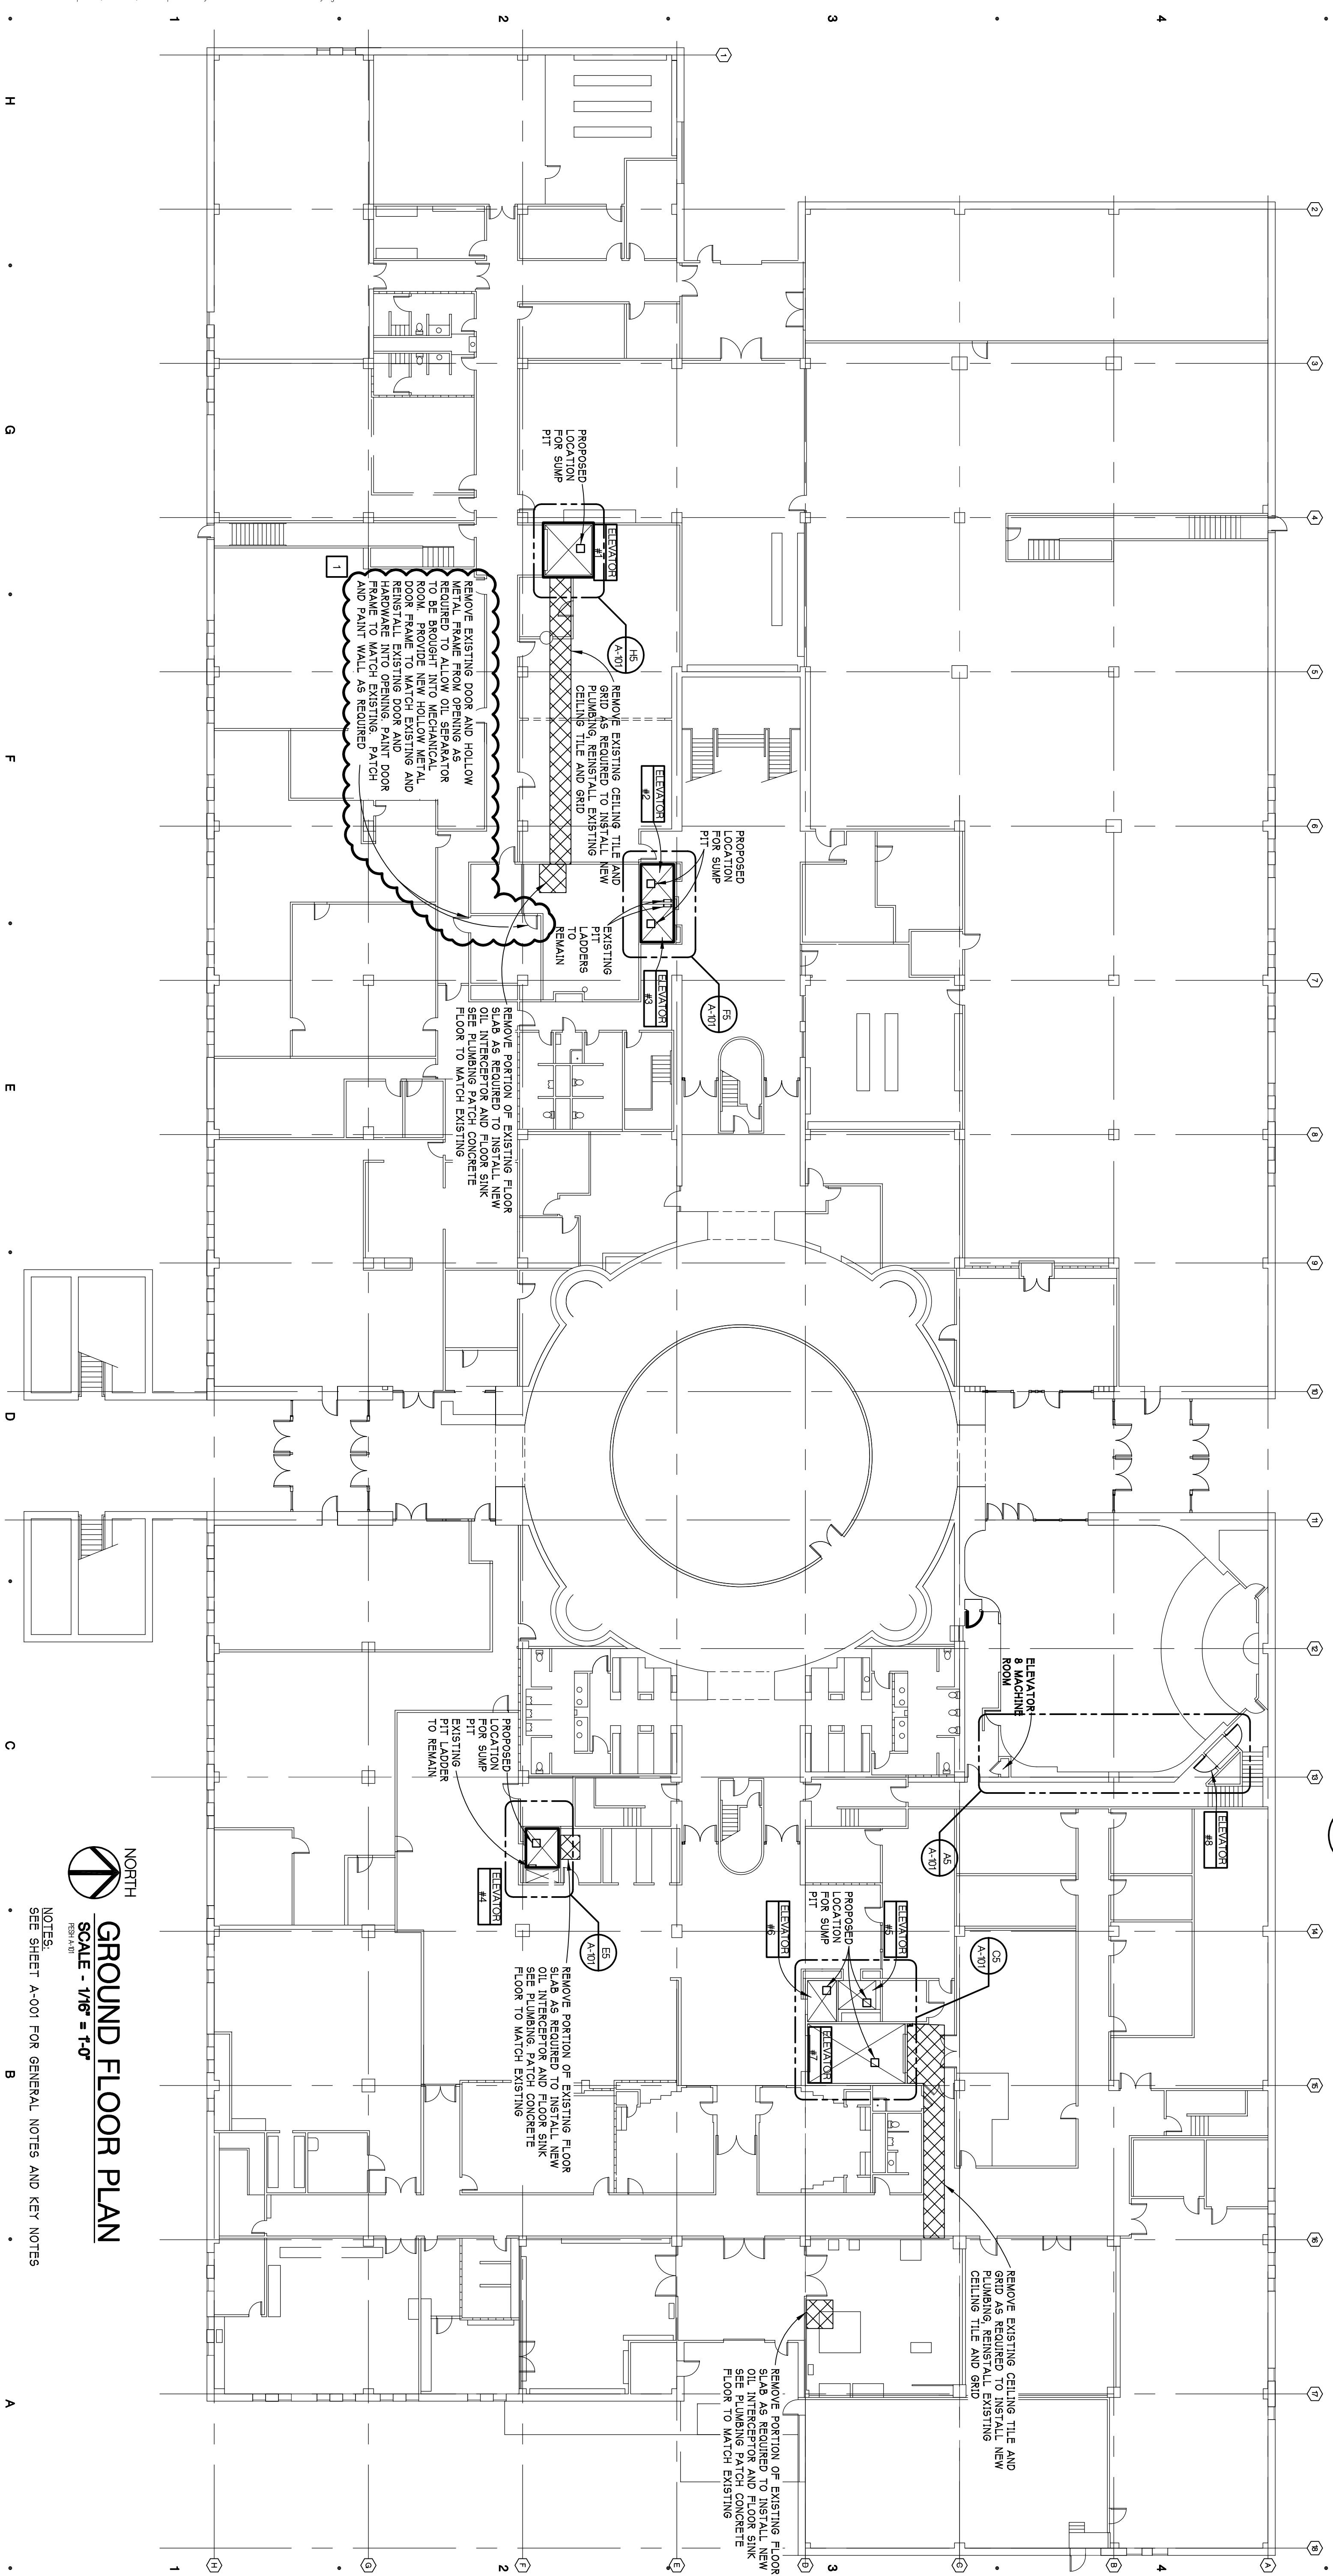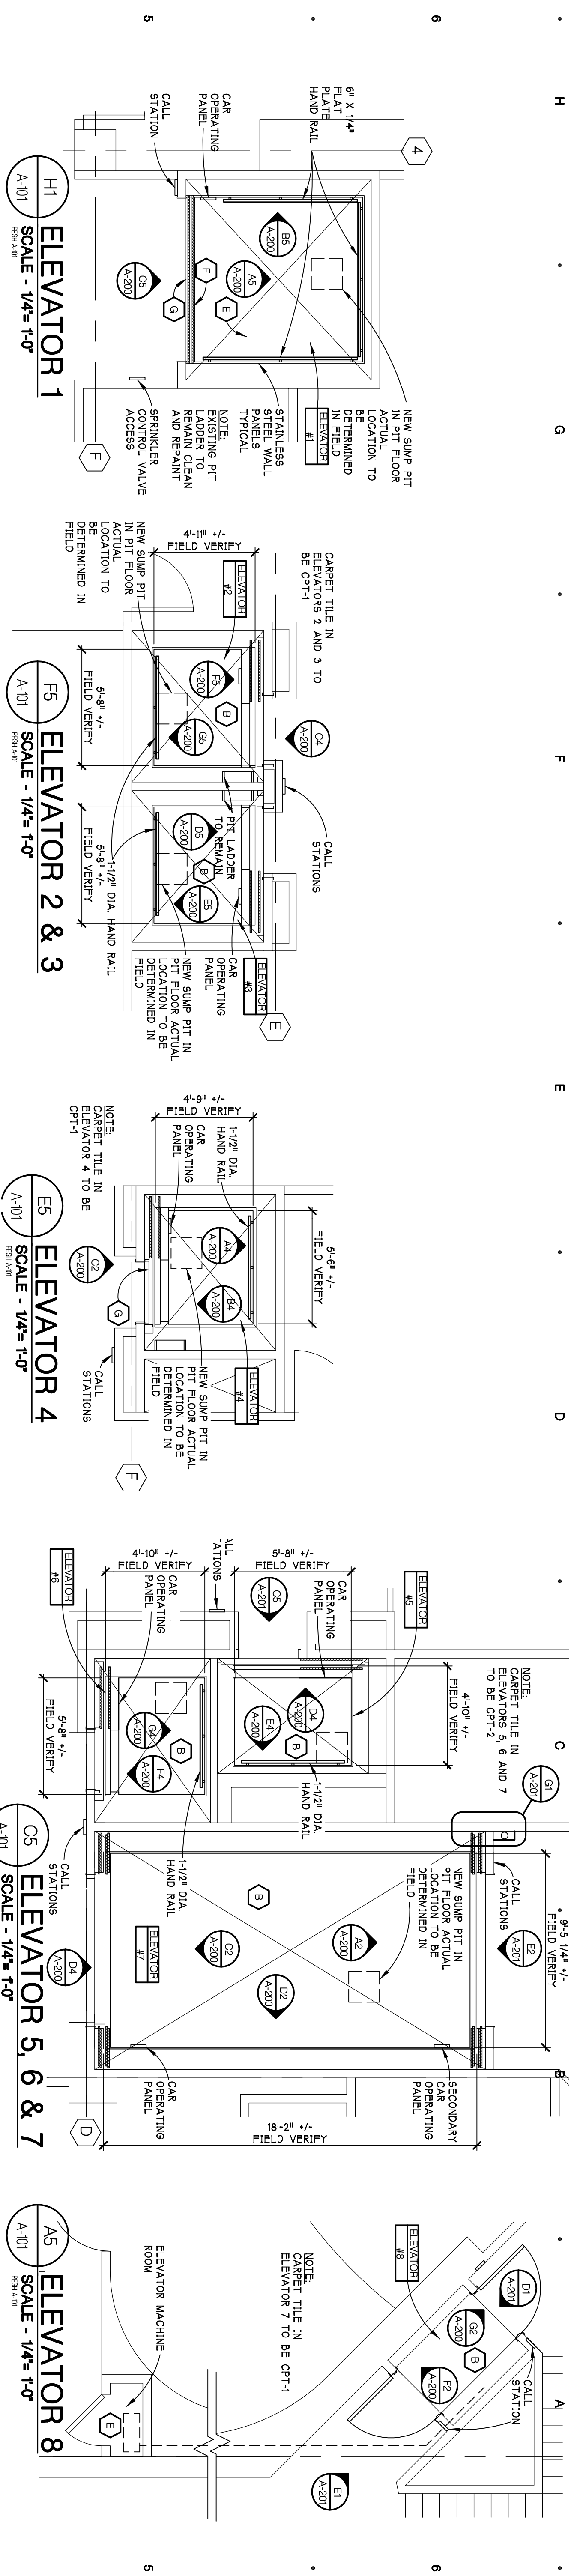

REMOVE EXISTING DOOR AND HOLD-UP
 FRAME AND REPAIR SURROUNDING
 WALLS TO MATCH EXISTING. NEW
 DOOR TO BE BROUGHT INTO MECHANICAL
 ROOM. PROVIDE NEW HOLD-UP METAL
 RODS TO SUPPORT DOOR AND REPAIR
 REINSTALL EXISTING DOOR AND
 FRAME TO MATCH EXISTING. PATCH
 AND PAINT WALL AS REQUIRED.


REMOVE PORTION OF EXISTING FLOOR
 SLAB AS REQUIRED TO INSTALL NEW
 OIL INTERCEPTOR AND CONCRETE
 FLOOR TO MATCH EXISTING

REMOVE PORTION OF EXISTING FLOOR
 SLAB AS REQUIRED TO INSTALL NEW
 OIL INTERCEPTOR AND FLOOR SINK
 FOR PUMPING PATCH CONCRETE
 FLOOR TO MATCH EXISTING

REMOVE PORTION OF EXISTING FLOOR
 OIL INTERCEPTOR AND FLOOR SINK
 SEE PLUMBING PATCH AND CONCRETE
 FLOOR TO MATCH EXISTING


REMOVE EXISTING CEILING TILE AND
 GRID AS REQUIRED TO INSTALL NEW
 PLUMBING, REINSTALL EXISTING
 CEILING TILE AND GRID

GROUND FLOOR PLAN
 SCALE - 1/8" = 1'-0"

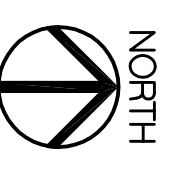

NOTES:
 SEE SHEET A-201 FOR GENERAL NOTES AND KEY NOTES

<p>21-302 PROJECT NUMBER</p> <p>A-101 SHEET NUMBER</p>	<p>GROUND FLOOR ELEVATOR PLAN</p> <p>SHEET TITLE</p>	<p>LEITCH BATES CONSULTANTS 950 Boston Street SE Grand Rapids, MI 49507</p>	<p>MATRIX CONSULTING ENGINEERS, INC. 1601 E César E. Chavez Ave Lansing, MI 48906</p>	<p>PROJECT 702 WEST KALAMAZOO ST. LANSING, MI 48915</p>	<p>LIBRARY OF MICHIGAN AND HISTORICAL CENTER, UPGRADE ELEVATOR CONTROLS</p>	<p>DTMB Technology Management & Design</p>	<p>File No: 171/20106.TYC</p>	<p>HOBBS + BLACK ARCHITECTS 117 E. Allegan Street Lansing, MI 48933 P: 517.484.4870 www.hobbs-black.com</p>	<p>APPENDIX 1 ISSUED FOR BIDDING 09/16/2021 DATE ISSUED 09/16/2021 DRAWN BY JMW CHECKED BY JMW</p>	<p>Sheet 209 - 2406 © Copyright 2021 by Hobbs+Black+Architects, Inc. All Rights Reserved</p>
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H5 ELEVATOR 1
 A-103
 SCALE - 1/4" = 1'-0"
 PESH A-103

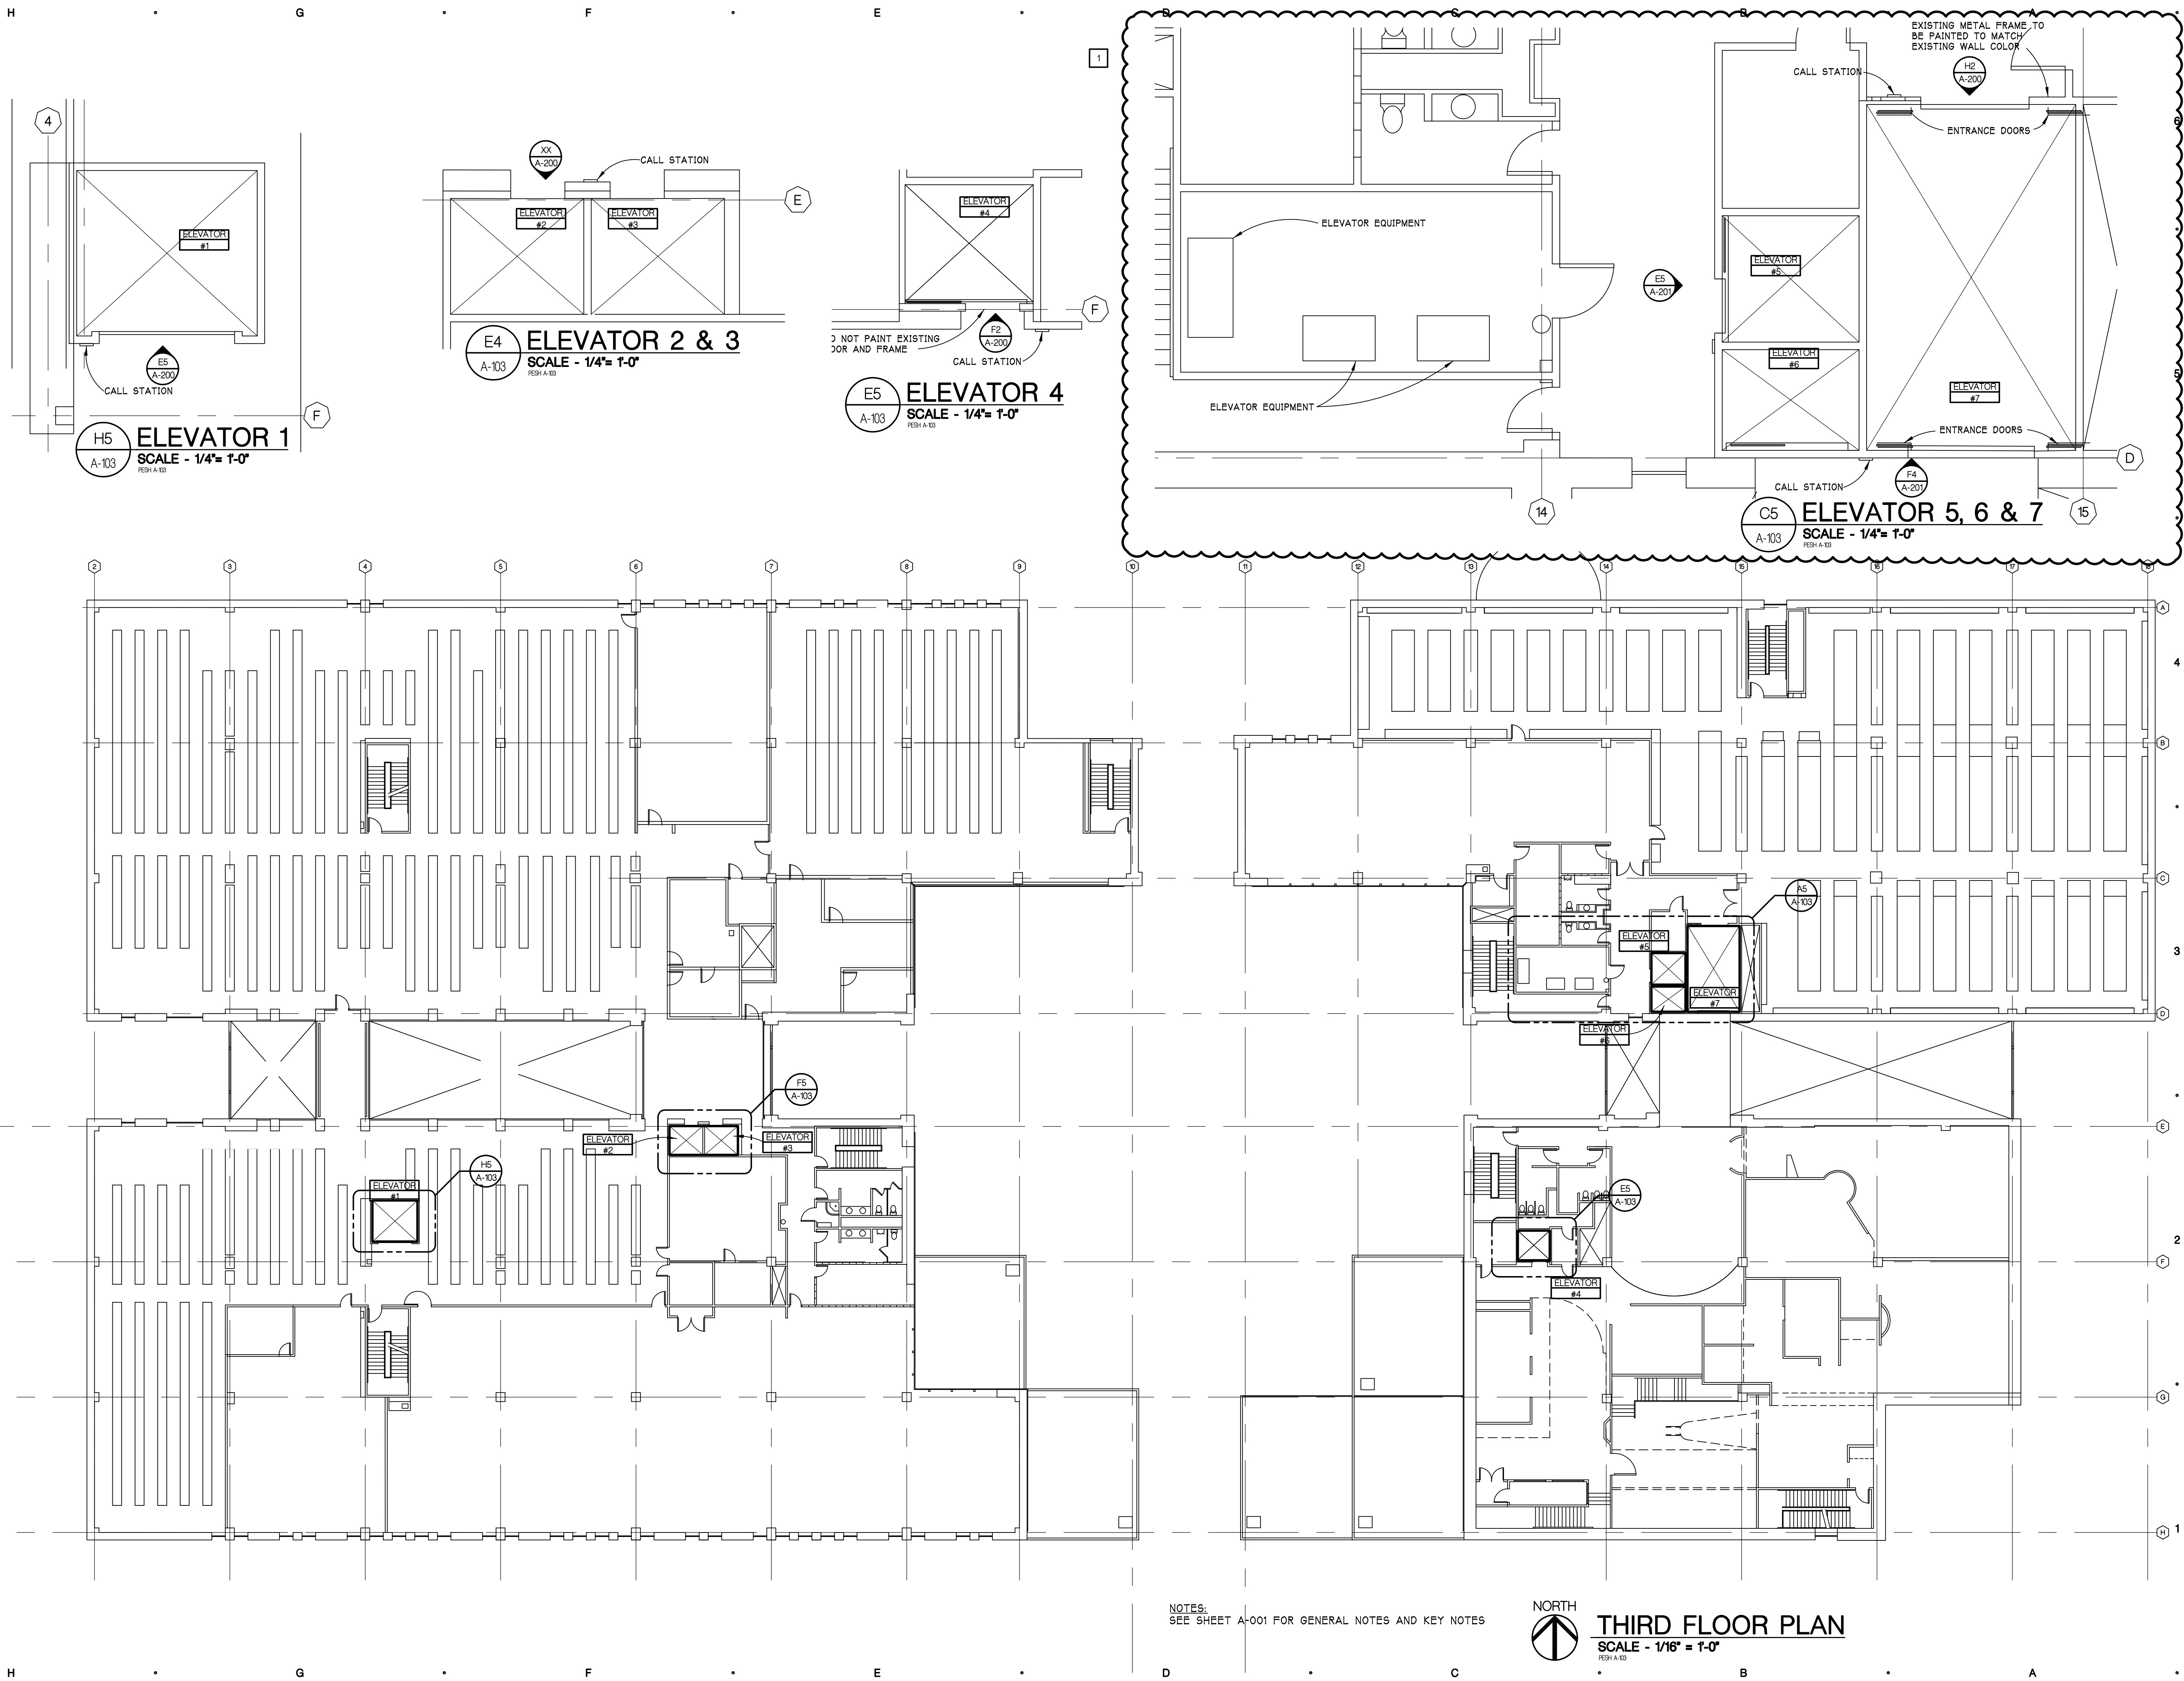E4 ELEVATOR 2 & 3
 A-103
 SCALE - 1/4" = 1'-0"
 PESH A-103

E5 ELEVATOR 4
 A-103
 SCALE - 1/4" = 1'-0"
 PESH A-103

C5 ELEVATOR 5, 6 & 7
 A-103
 SCALE - 1/4" = 1'-0"
 PESH A-103

NOT PAINT EXISTING
 DOOR AND FRAME

EXISTING METAL FRAME TO
 BE PAINTED TO MATCH
 EXISTING WALL COLOR

NOTES:
 SEE SHEET A-001 FOR GENERAL NOTES AND KEY NOTES

THIRD FLOOR PLAN
 SCALE - 1/16" = 1'-0"
 PESH A-103

1	ADDENDUM 1	10/01/2021
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PROJECT



**THIRD FLOOR
 ELEVATOR
 PLANS**

SHEET TITLE

21-302
 PROJECT NUMBER


A-103
 SHEET NUMBER

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 Layout: A-103
 Plotted by: jmontmore

DEMOLITION NOTES


- 1 EXISTING EQUIPMENT TO REMAIN.
- 2 DISCONNECT & REMOVE EXISTING EQUIPMENT. ASSOCIATED CONDUIT & WIRE TO REMAIN FOR NEW EQUIPMENT.
- 3 NOT USED.
- 4 EXISTING DEVICE TO REMAIN UNTIL NEW INSTALLATION IS COMPLETE. UPON COMPLETION, DISCONNECT & REMOVE EXISTING DEVICE.
- 5 NOT USED.

ELEV. #1

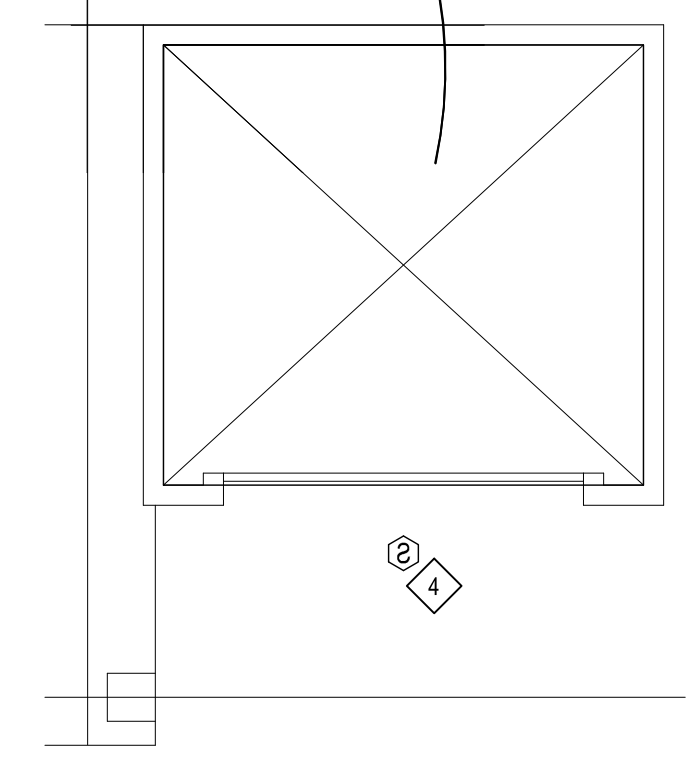

11 ELEVATOR 1
 SCALE: 1/4" = 1'-0"

ELEV. #2 ELEV. #3

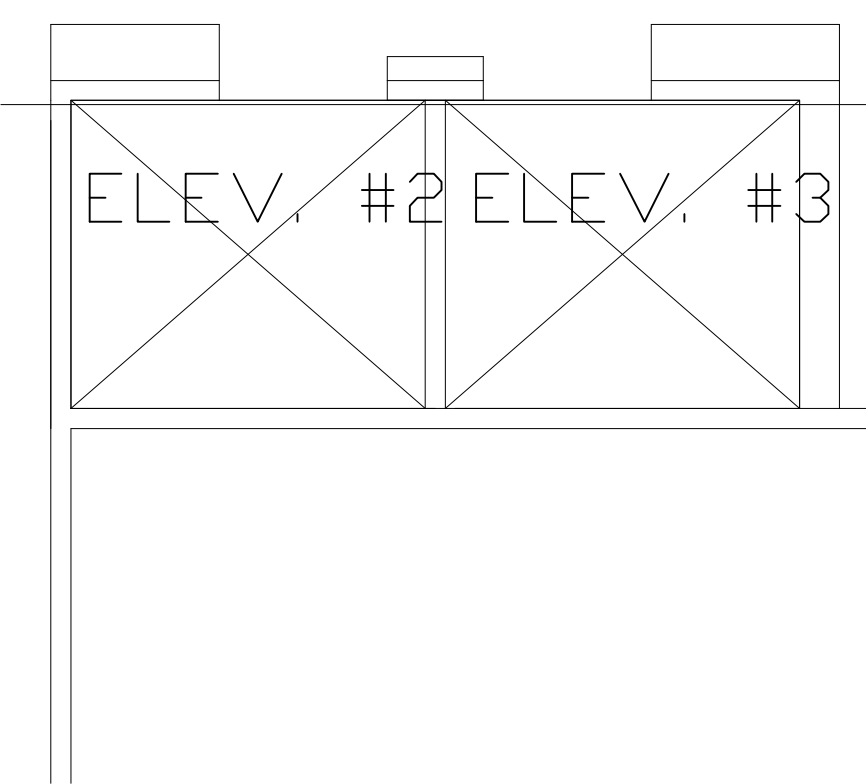

12 ELEVATOR 2 & 3
 SCALE: 1/4" = 1'-0"


ELEC. M 306

ELEV. #5

ELEV. #7

ELEV. #6

13 ELEVATOR 5, 6 & 7
 SCALE: 1/4" = 1'-0"

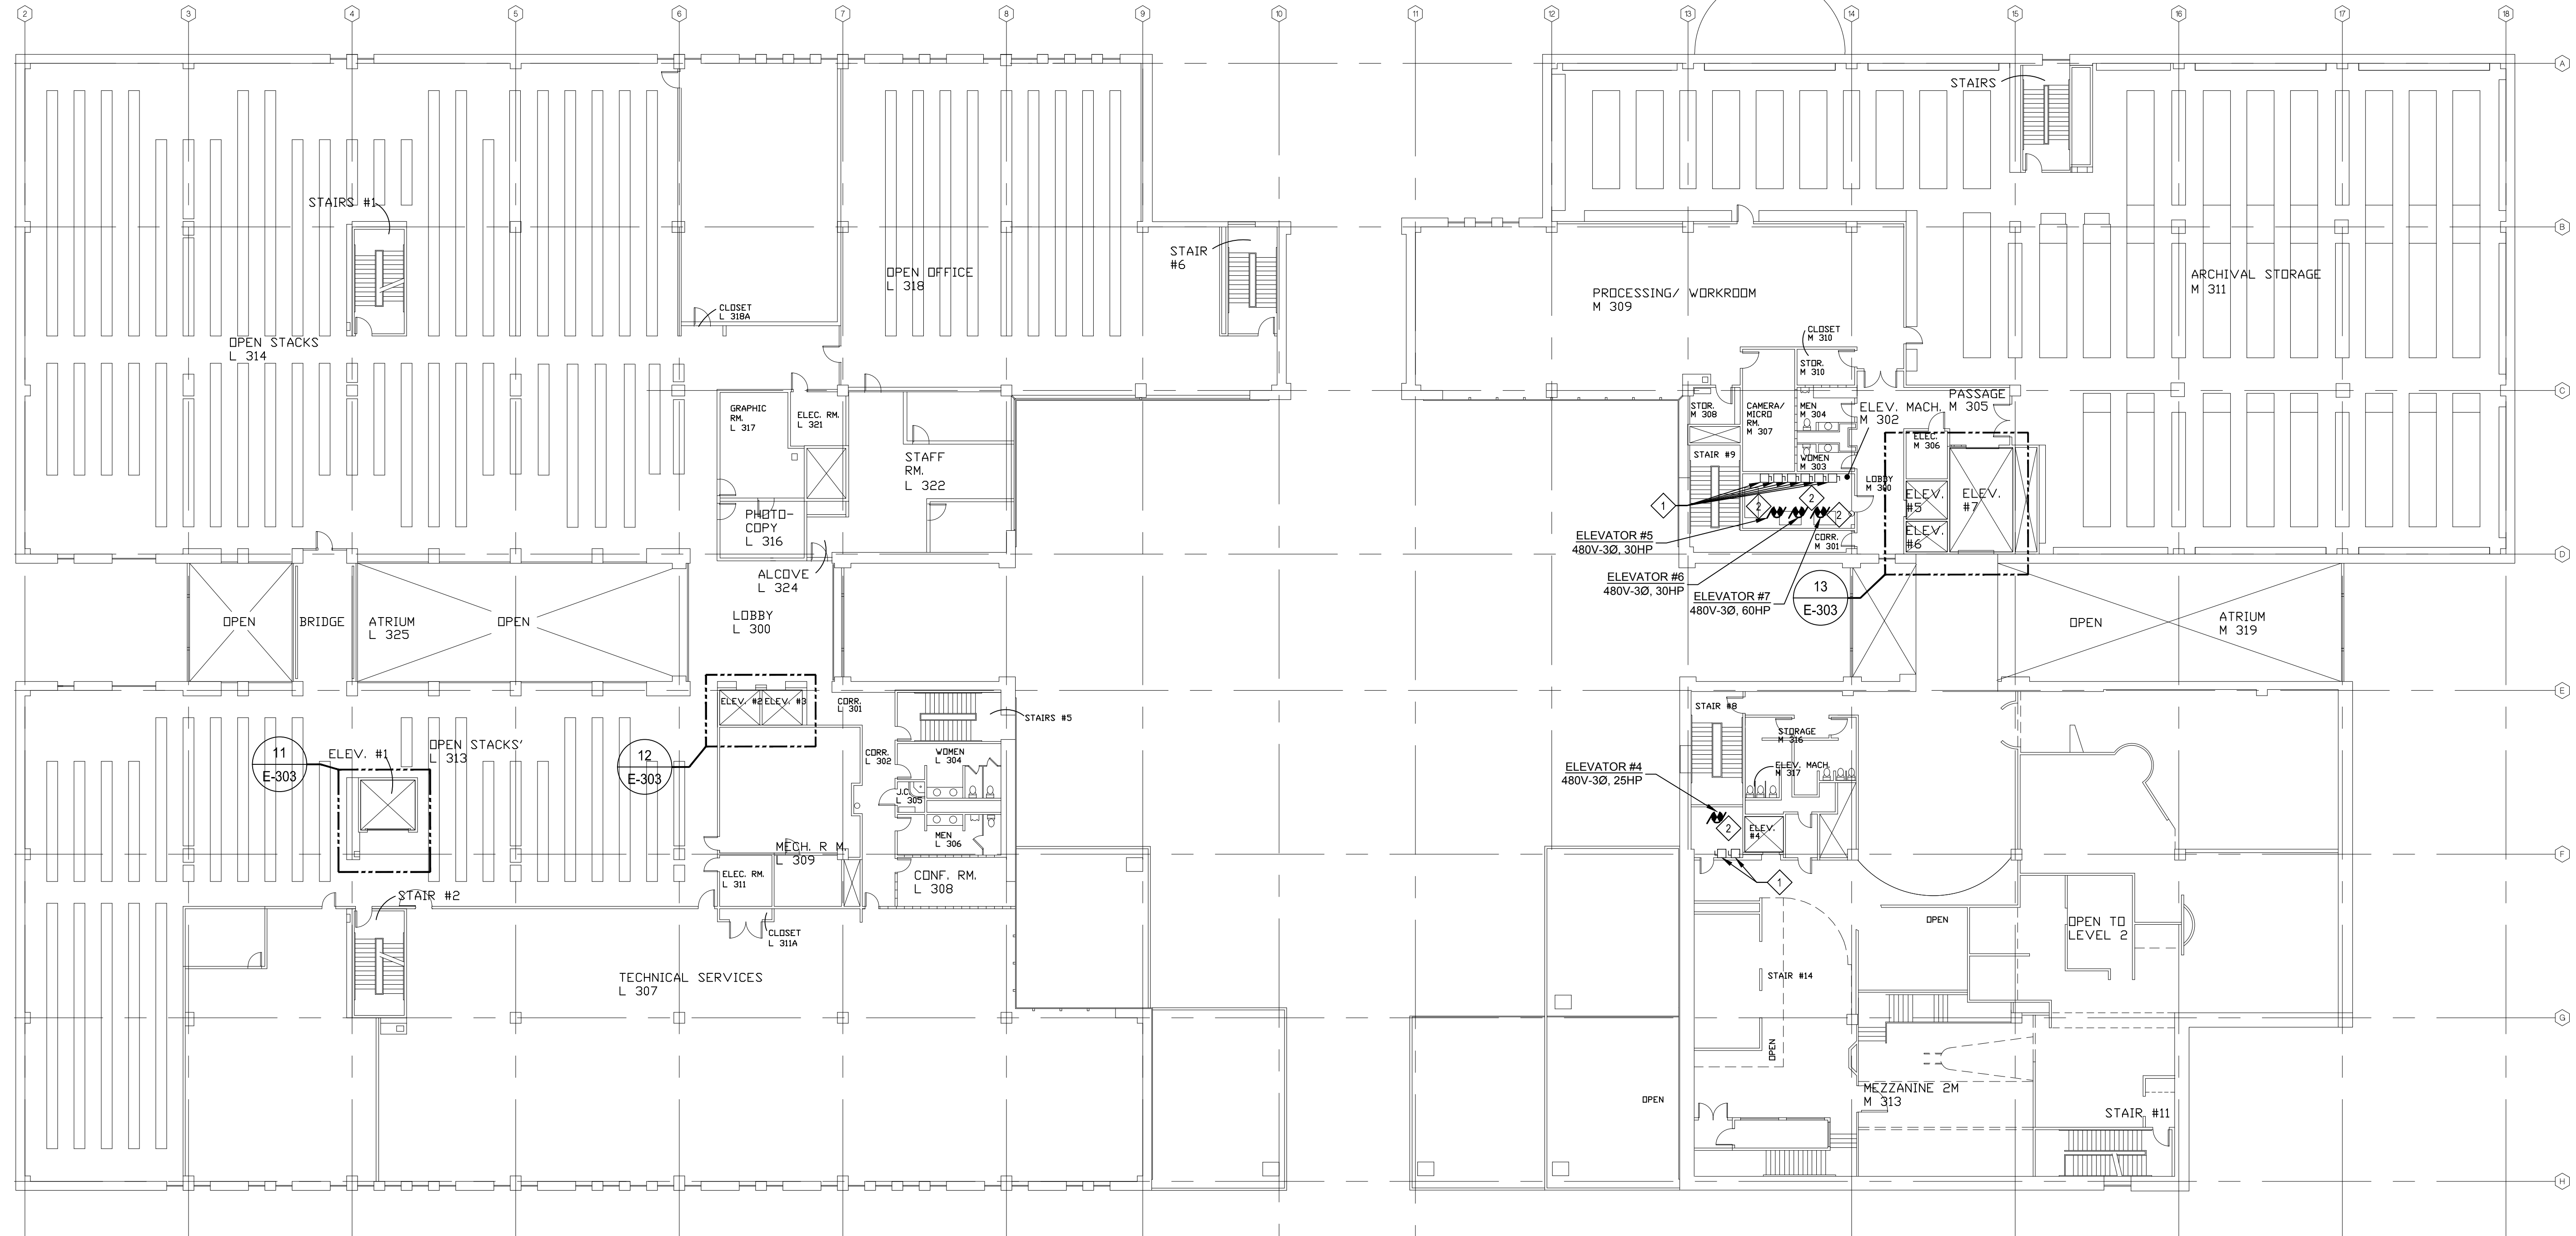

ELECTRICAL - THIRD FLOOR - DEMOLITION
 SCALE: 1/16" = 1'-0"

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**ELECTRICAL
 THIRD FLOOR
 DEMOLITION**





SHEET TITLE

21-302
 PROJECT NUMBER

E-303
 SHEET NUMBER

DEMOLITION NOTES

- 1 EXISTING EQUIPMENT TO REMAIN.
- 2 DISCONNECT & REMOVE EXISTING EQUIPMENT. ASSOCIATED CONDUIT & WIRE TO REMAIN FOR NEW EQUIPMENT.
- 3 NOT USED.
- 4 EXISTING DEVICE TO REMAIN UNTIL NEW INSTALLATION IS COMPLETE. UPON COMPLETION, DISCONNECT & REMOVE EXISTING DEVICE.
- 5 NOT USED.

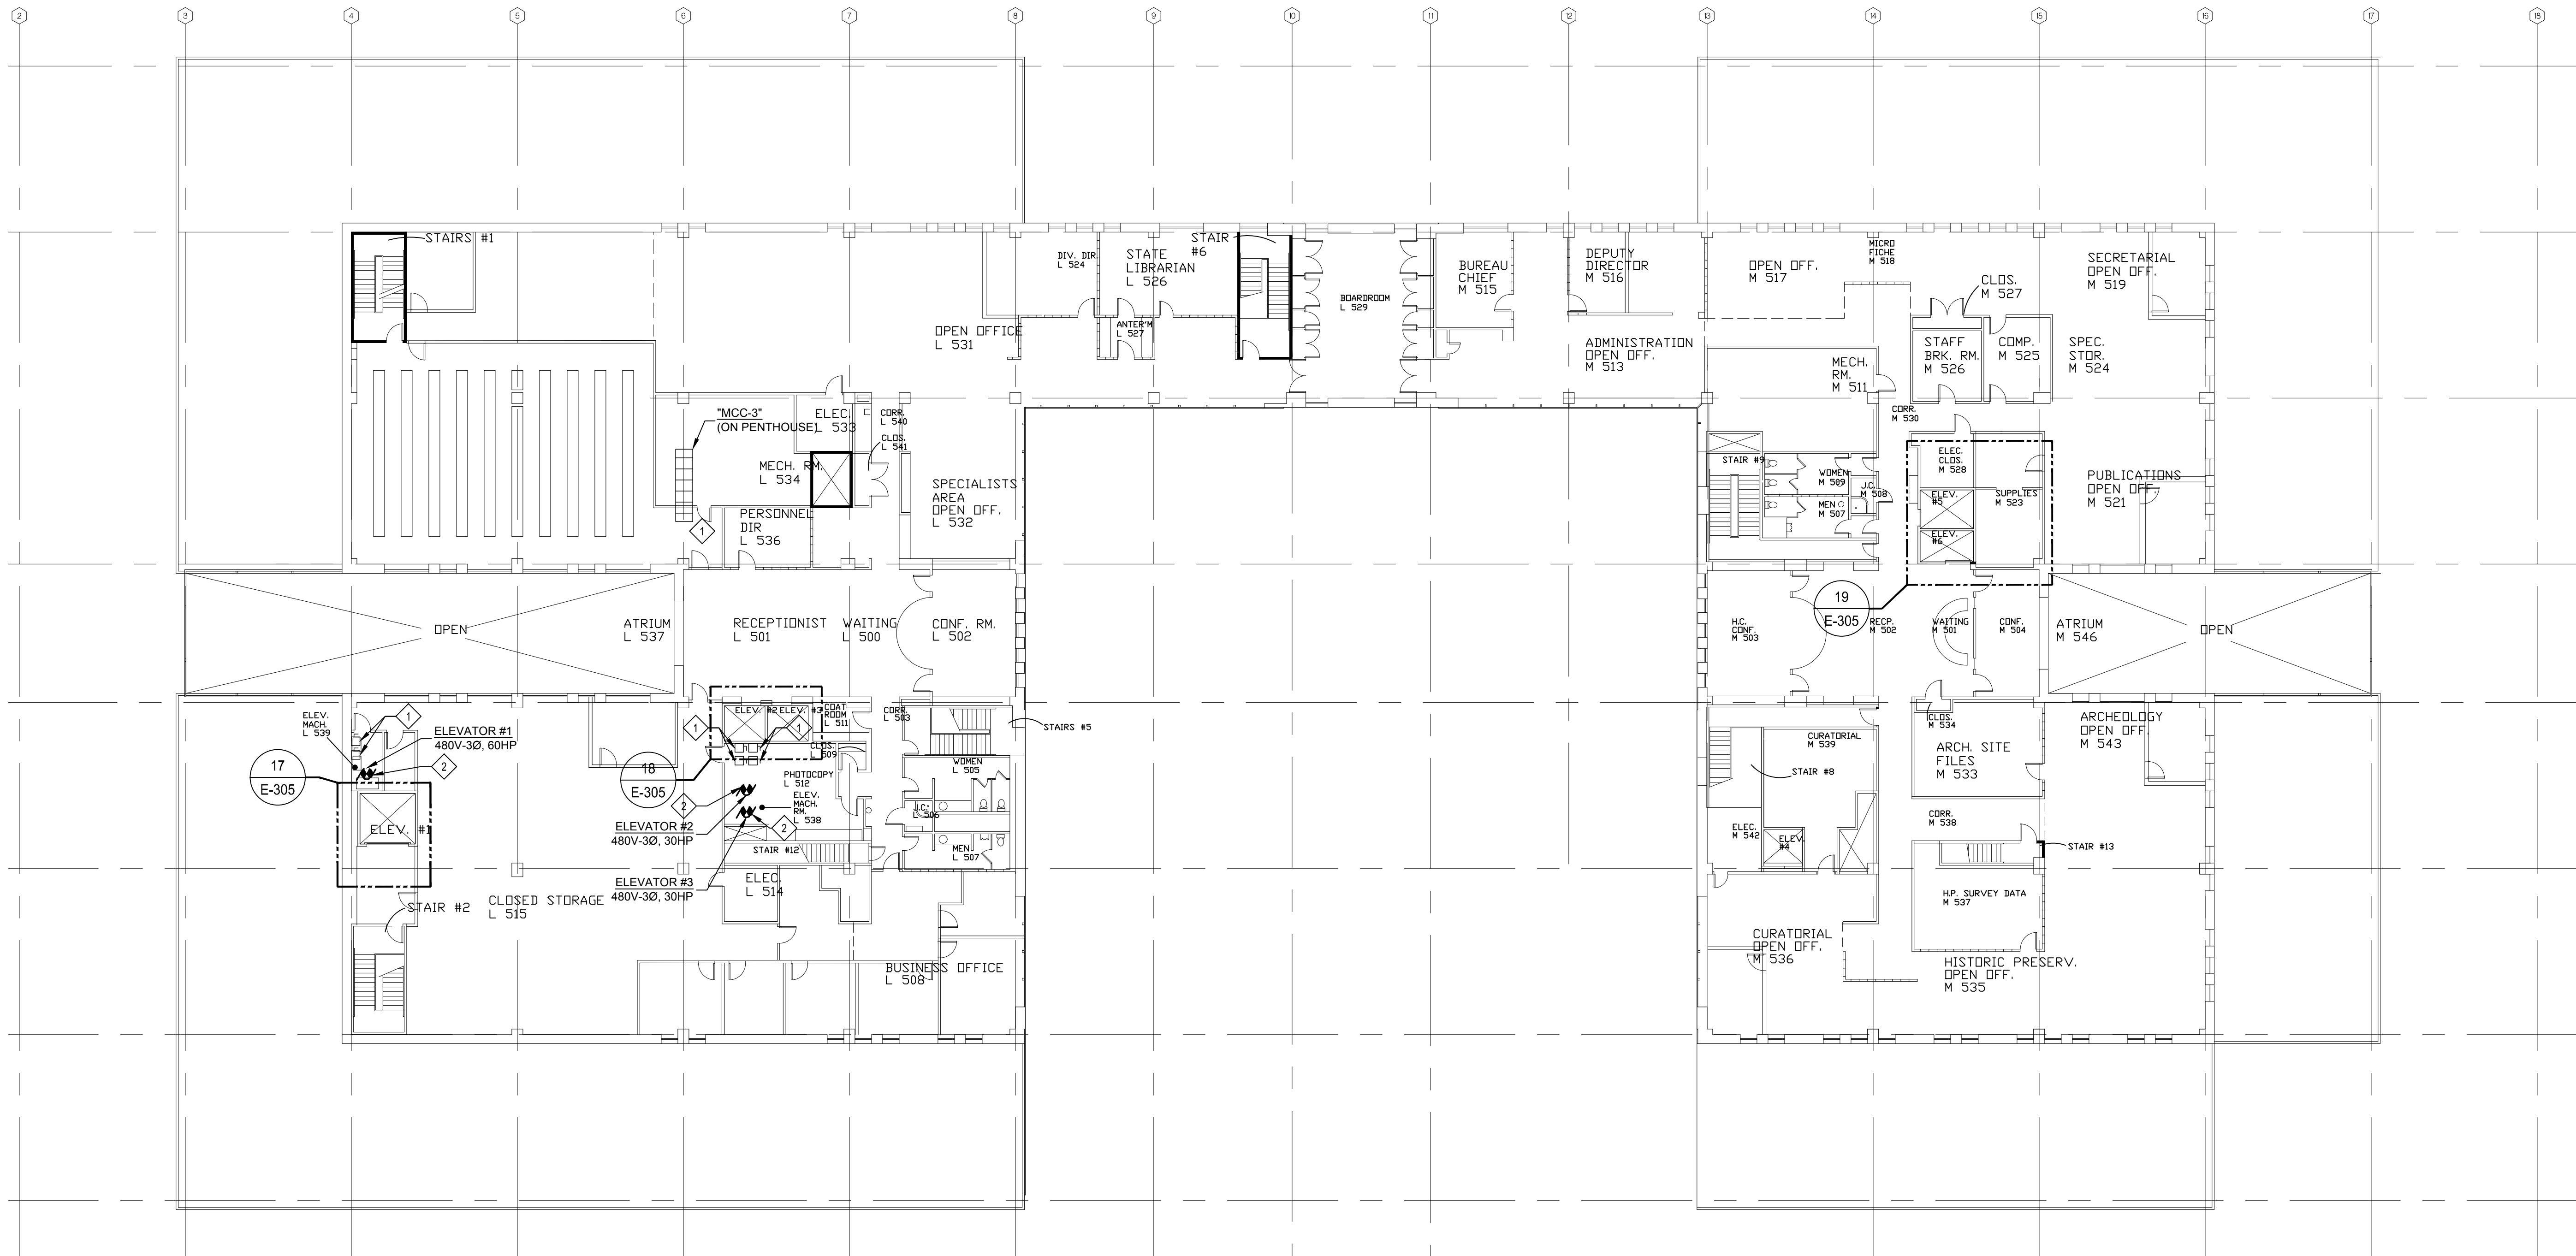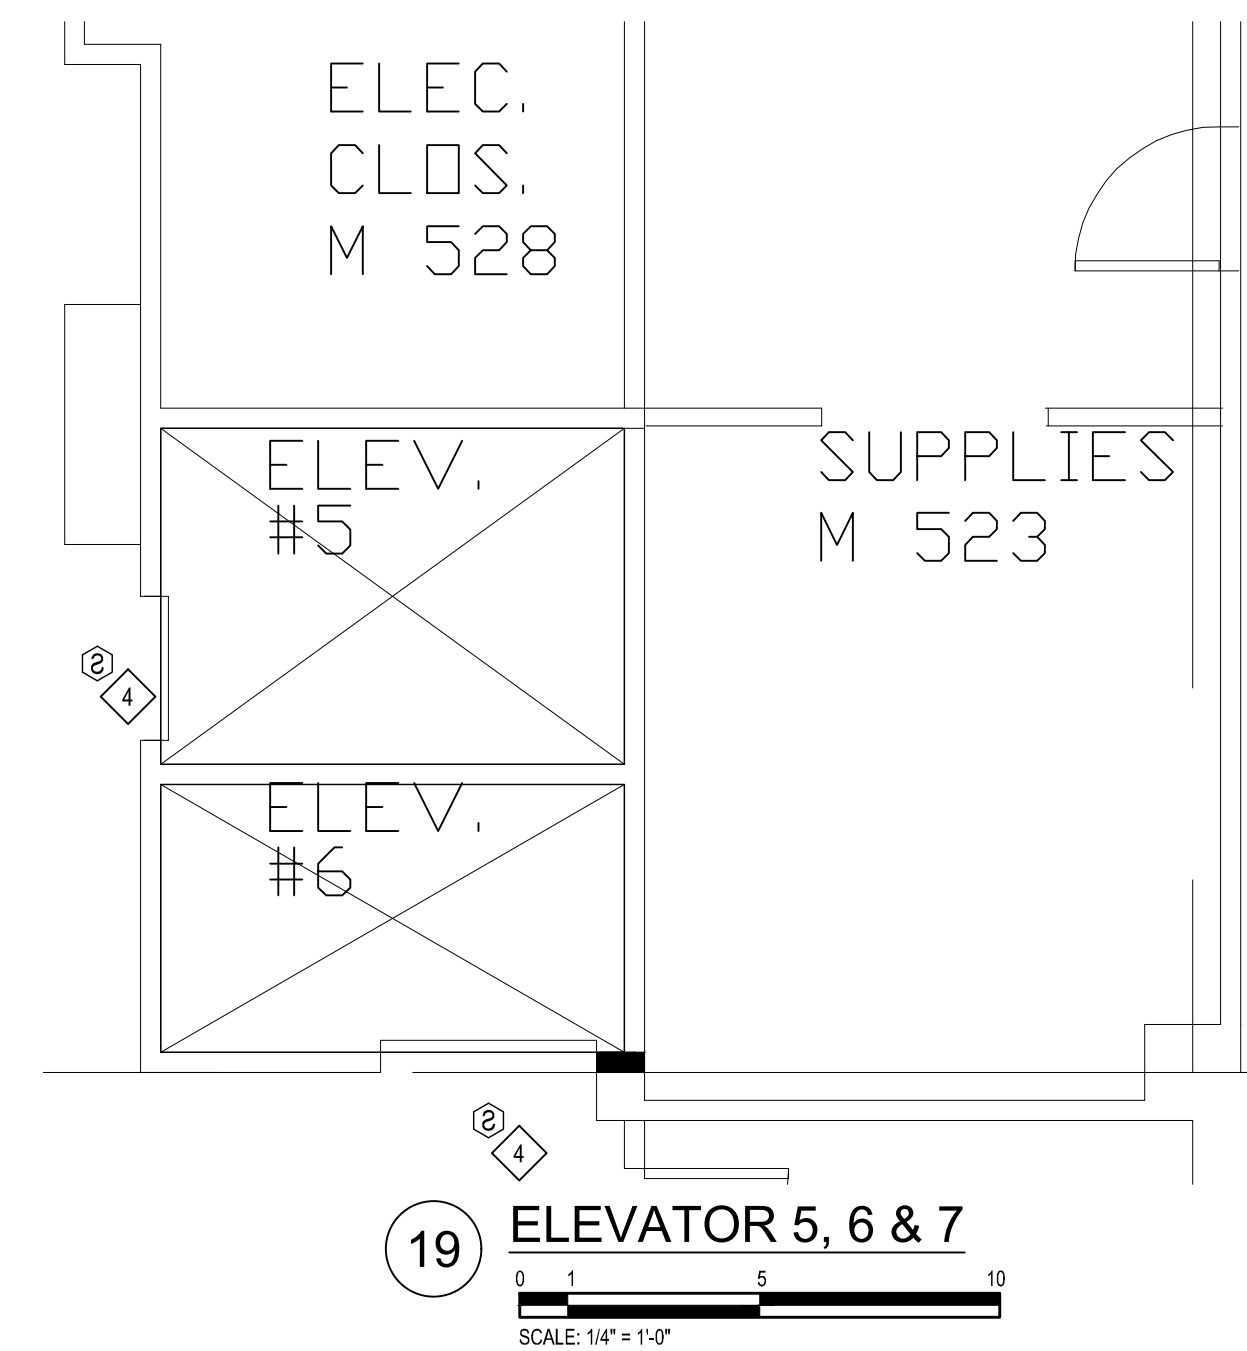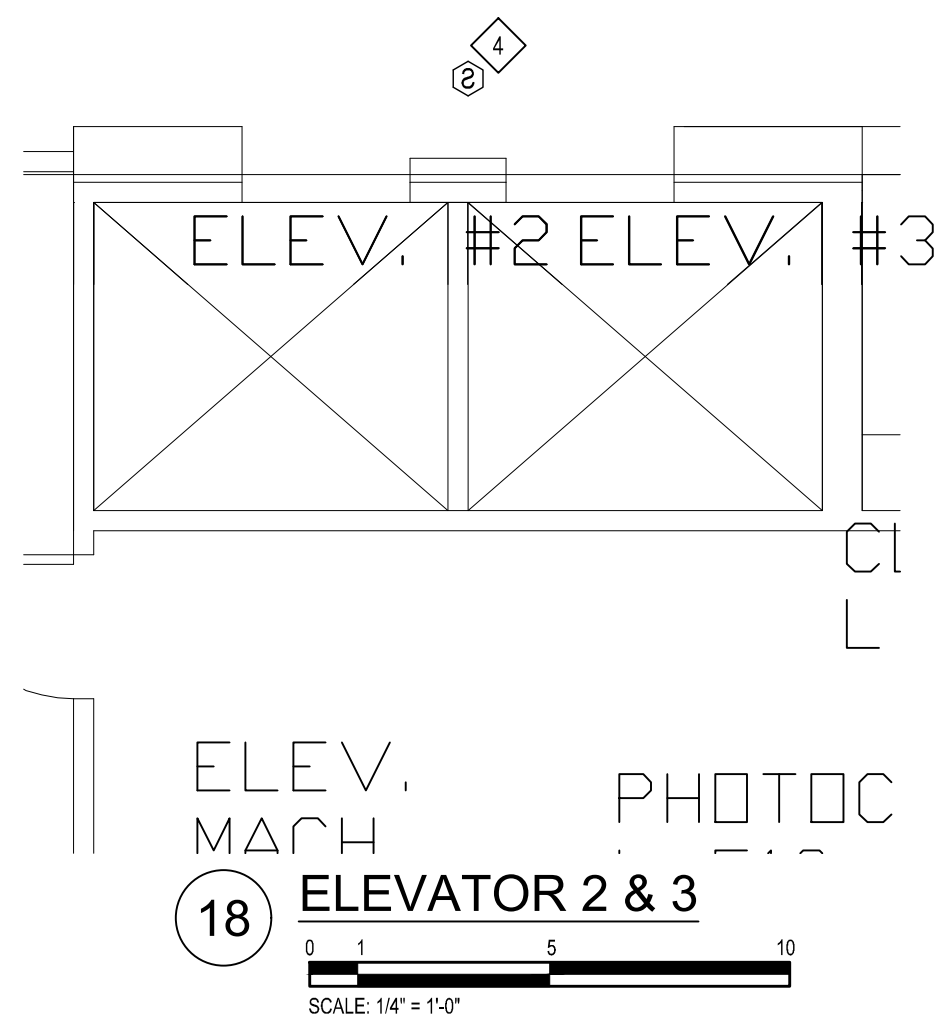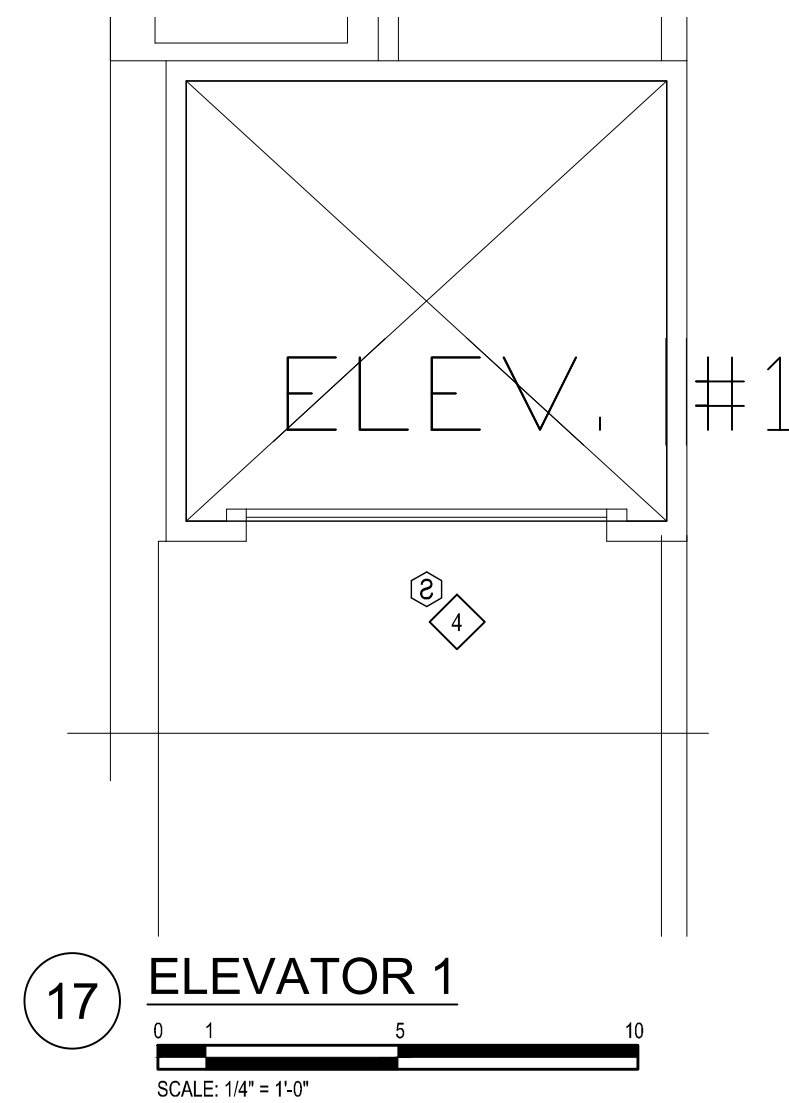

ELECTRICAL - FIFTH FLOOR - DEMOLITION
 SCALE: 1/16" = 1'-0"

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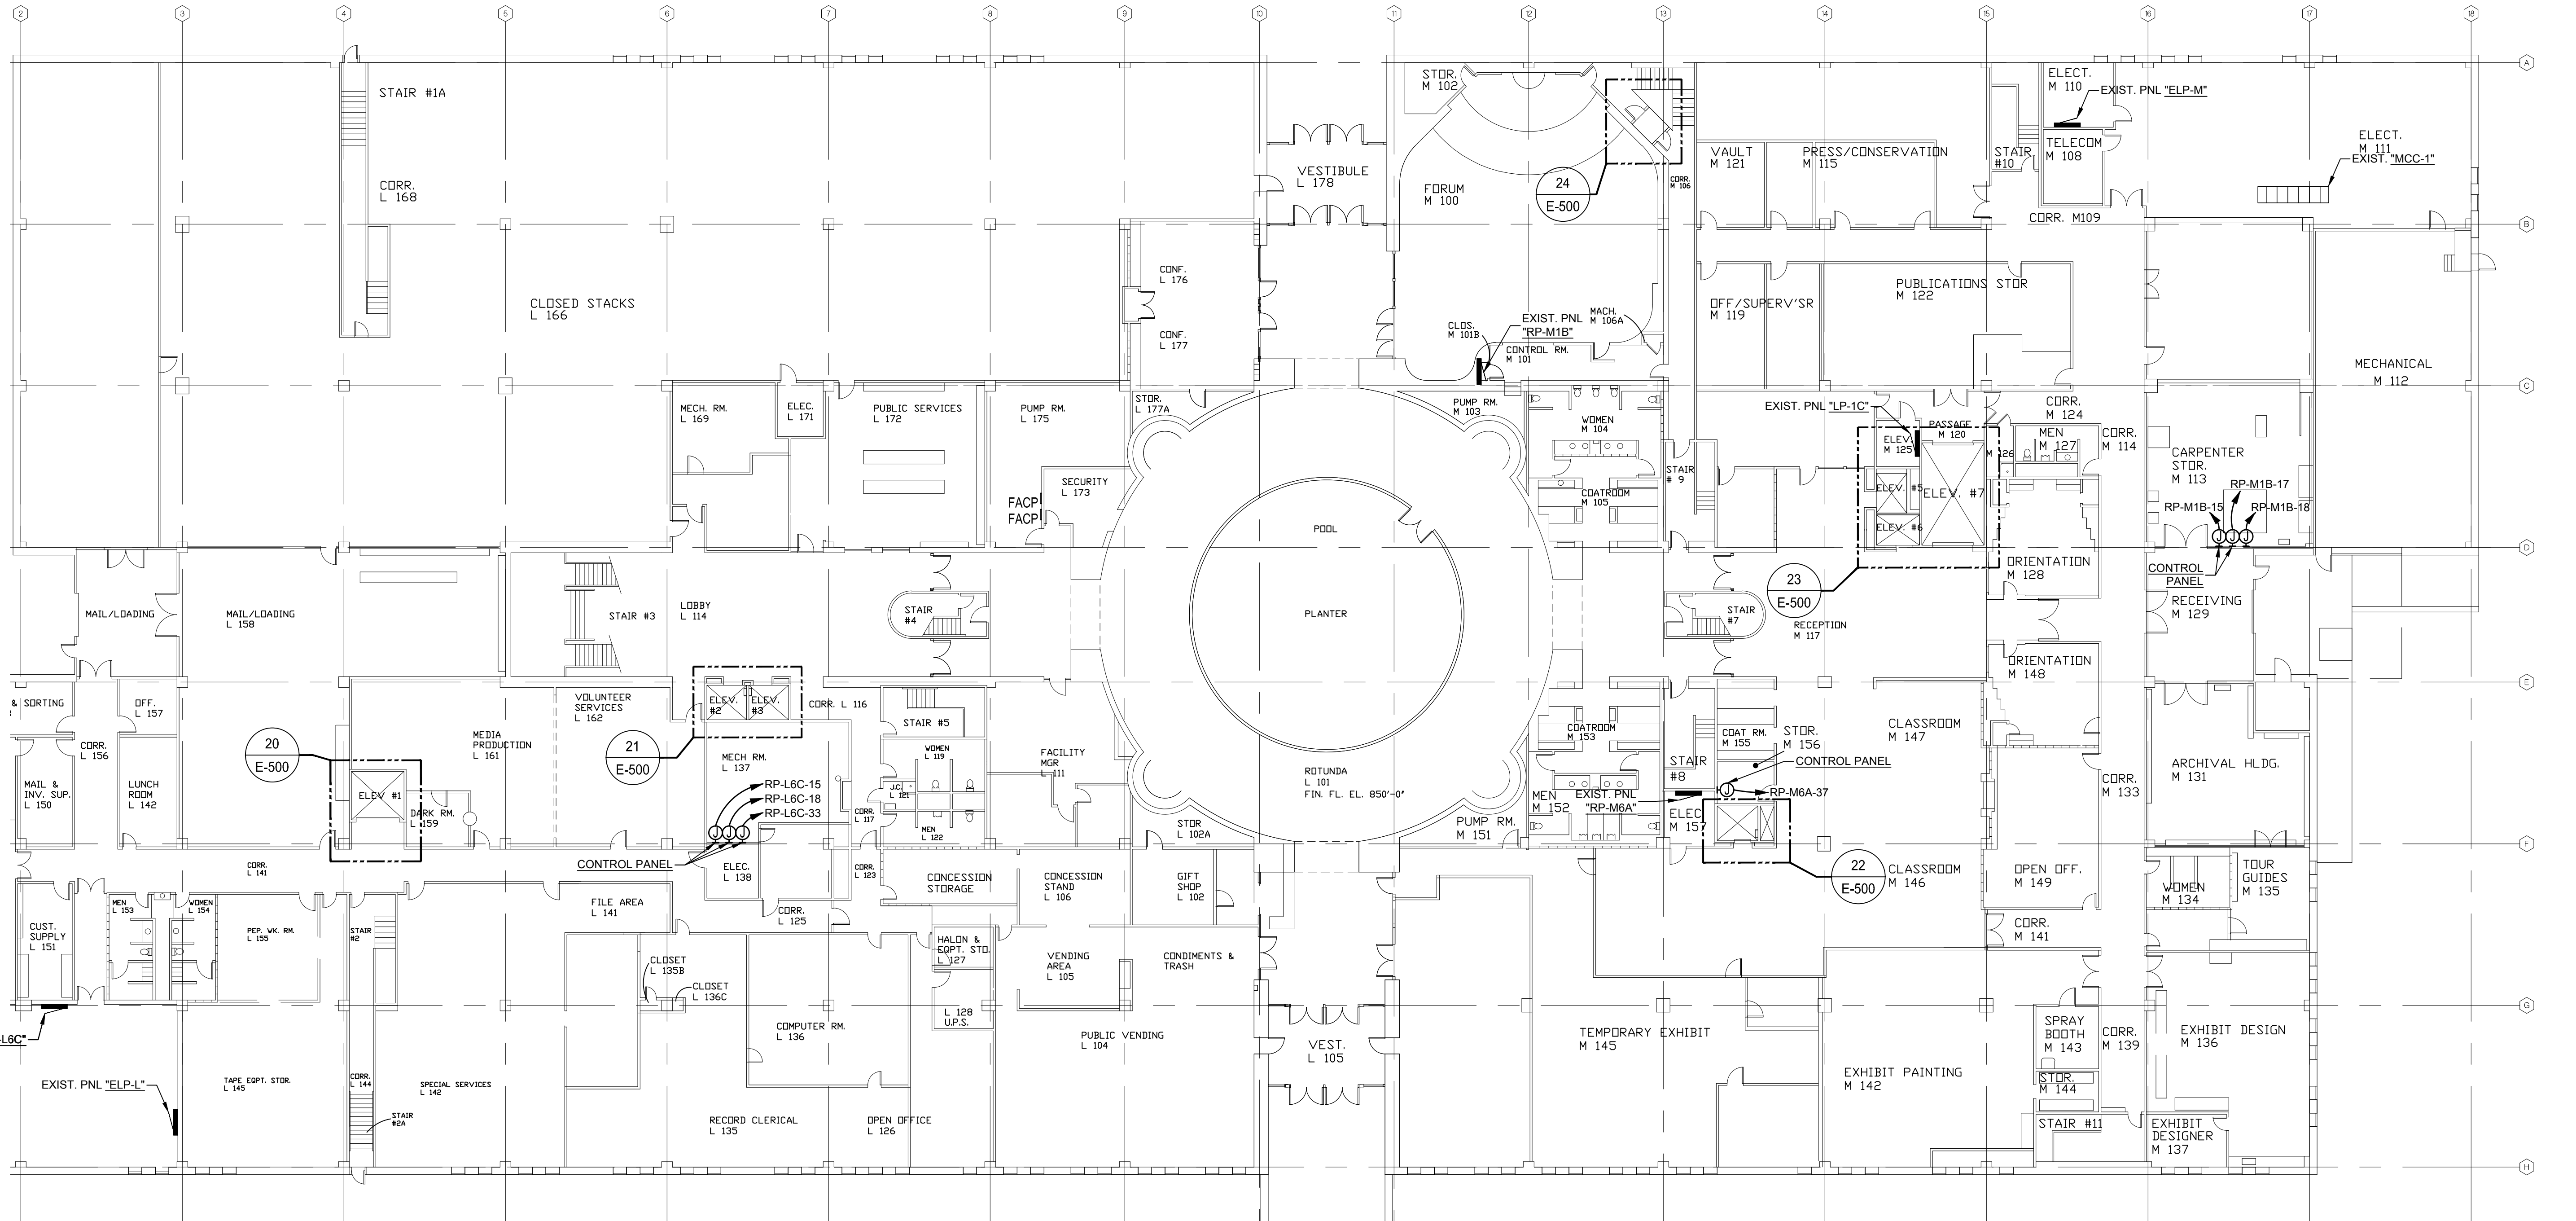
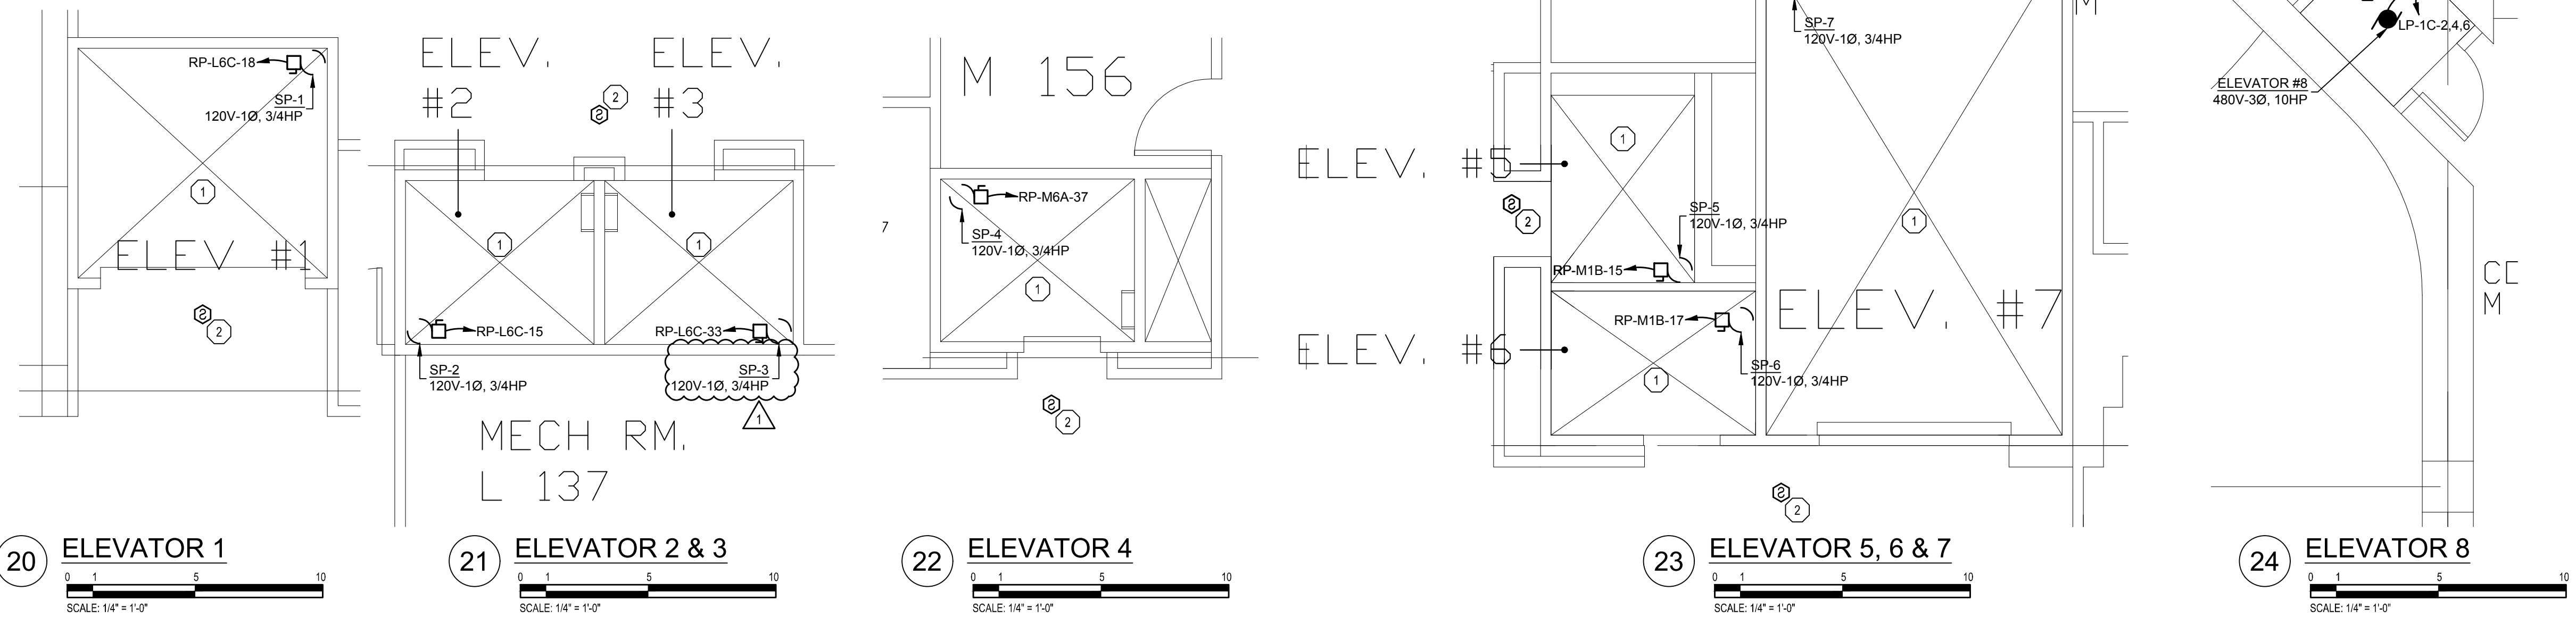
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ELECTRICAL FIFTH FLOOR DEMOLITION

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 21-302
 PROJECT NUMBER
 E-305
 SHEET NUMBER

ELECTRICAL KEY NOTES

- ① CONTRACTOR SHALL INSTALL NEW ELEVATOR PIT LIGHT. LIGHT SHALL BE PHOENIX VA-W-17LED-CW-FGC OR EQUAL. CONTRACTOR SHALL REUSE EXISTING CIRCUIT FOR LIGHT.
- ② NEW SMOKE DETECTOR SUPPLIED BY OWNER. CONTRACTOR SHALL INCLUDE RELAYS TO MANAGE ELEVATOR RECALL SYSTEM. TIE DEVICE INTO EXISTING FIRE ALARM SYSTEM. DEVICE SHALL BE PROGRAMMED BY FIRE ALARM MANUFACTURER.



ELECTRICAL - FIRST FLOOR - POWER
 SCALE: 1/16" = 1'-0"

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ELECTRICAL FIRST FLOOR POWER

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21-302	
PROJECT NUMBER	
E-500	
SHEET NUMBER	